

APPLICATION FOR CERTIFICATE OF APPROPRIATENESS

Ithaca Landmarks Preservation Commission

108 E. Green Street – 3rd floor

Ithaca, NY 14850 Ph: 607-274-6550

ltruame@cityofithaca.org

www.cityofithaca.org/boardscommittees/ilpc/index.cfm

Date: Building Permit App	lication # (required):
Applicant's Name:	Phone:
Applicant's E-mail address (required):	
Property Address:	
Owner's Name (if different from Applicant): _	
Owner's Mailing Address:	
Proposed Work Includes (check all that apply):
New Construction	☐ Site Changes (paving, fencing, patios, etc.)
□ Addition	□ Signage
☐ Accessory Structure	☐ Demolition
☐ Alteration: primary structure	☐ Alteration: accessory structure

Submittal Requirements

All documents are to be sent to the attention of Lynn C. Truame at the above address. Staff level review:

Submit one hard copy and one electronic copy of application and attachments. See the <u>City of Ithaca Historic District and Landmark Design Guidelines</u> for a description of work that is eligible for this expedited review process.

ILPC Review:

Submit eleven (11) hard copies and one electronic copy of application form and all attachments. Complete applications must be received by 4:00 pm on the last Tuesday of the month, 14 days prior to the regular ILPC meeting at which the application will be reviewed. ILPC meetings are held the second Tuesday of each month.

Applications must be accompanied by thorough documentation of existing conditions and proposed changes, including (as applicable) photographs of existing conditions; site plans showing location and dimensions of proposed change; drawings or sketches showing proposed changes on each affected elevation; description of design details and materials to be used (manufacturer's data sheets may be used); samples of proposed materials; scale drawings of any proposed signs

including colors, typeface, and illumination details; historic photographs, if the intention of the project is to return a property to a documented prior condition; and a statement from a qualified contractor or design professional attesting to the physical condition of any element that is proposed for replacement due to deterioration.
Description of Proposed Changes (use additional sheets if necessary):
Reasons for Proposed Changes (use additional sheets if necessary):

Required Public Notification

Upon application for a Certificate of Appropriateness, a public notice of the proposal must be posted by the owner or owner's representative on the property for a minimum of 10 days. This notice must remain in place until a decision to approve or deny the Certificate of Appropriateness has been made. The notice must be placed at or near the property line in the front yard so that it will be plainly visible from the street, and, in cases where a property has frontage on more than one street, an additional sign must be placed at or near the property line on any additional street frontage.

Standard signs for this purpose are available for purchase from the City of Ithaca, Department of Planning and Development, at a cost of \$10.50 each. Alternatively, an applicant may create their own signs, as long as the following required content is included:

PROPOSED EXTERIOR OR SITE ALTERATIONS TO THIS PROPERTY WILL BE REVIEWED BY THE ITHACA LANDMARKS PRESERVATION COMMISSION ON [insert date], BEGINNING AT 5:30 pm IN THE [insert location of meeting] PUBLIC COMMENT MAY BE SUBMITTED IN ADVANCE OF, OR DURING, THE ABOVE-REFERENCED PUBLIC HEARING. FOR MORE INFORMATION CONTACT: <a href="https://linear.org/line

Applicant's Statement

I understand that incomplete applications cannot be processed and will result in delay. This application is complete to the best of my knowledge and includes the following attachments (check all that apply):


all that apply):						
photographs of existing conditions						
☐ site plans showing location and dimensions of proposed change						
☐ drawings or sketches showing proposed changes on each affected elevation						
description of design details and materials to be used						
☐ samples of proposed materials						
☐ scale drawings of any proposed signs including colors, typeface, and illumination details ☐ historic photographs, if the intention of the project is to return a property to a						
						documented prior condition
☐ statement from a qualified contractor or design professional attesting to the physical						
condition of any element that is proposed for replacement due to deterioration						
□ other (specify):						
Applicant's Signature: Date:						
STAFF USE ONLY:						
Date Received:						
Staff Review: ☐ yes ☐ no Approved: ☐ yes ☐ no Referred to ILPC: ☐ yes ☐ no						
ILPC Review: ☐ yes ☐ no						
Date of Public Hearing:						



Sage Chapel Cornell University

John Milner Associates, Inc., Architects

The Design Team

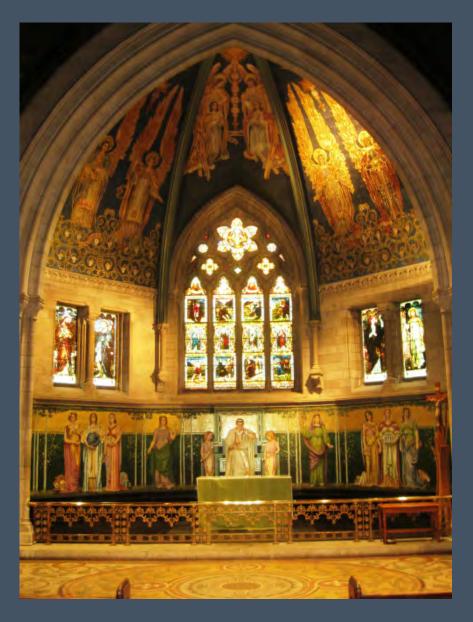

Preservation Architects
John Milner Associates, Inc.
Alexandria, Virginia

Structural Engineers
Robert Silman Associates, PC
Boston, Massachusetts


Mechanical Engineers
Princeton Engineering Group, LLC
Princeton, New Jersey


Civil Engineers
T.G. Miller, PC
Ithaca, New York

Stained Glass Conservator E.S. Taylor Studio, LLC Richmond, Virginia


Decorative Painting Consultant John Tiedemann, Inc. North Arlington, New Jersey


Chapel Evolution – Original Building 1873-1875

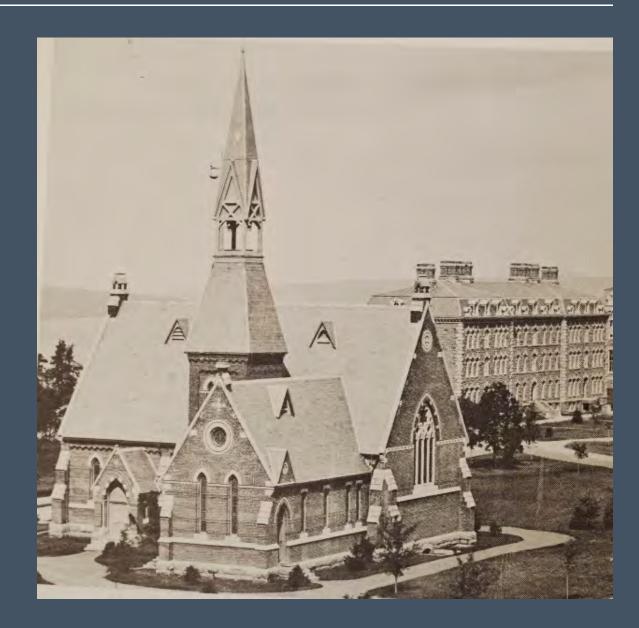

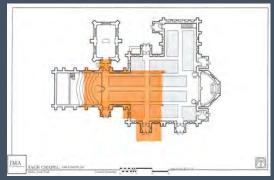


Chapel Evolution – Memorial Chapel, 1882-84

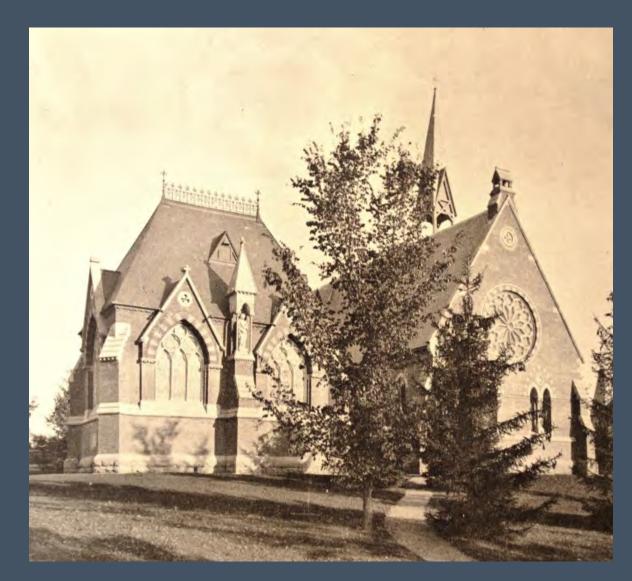

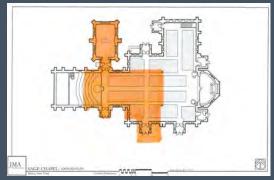



Chapel Evolution – 1898-1899 Addition



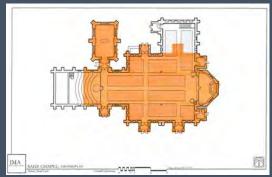



Chapel Evolution – 1903-1905 Addition

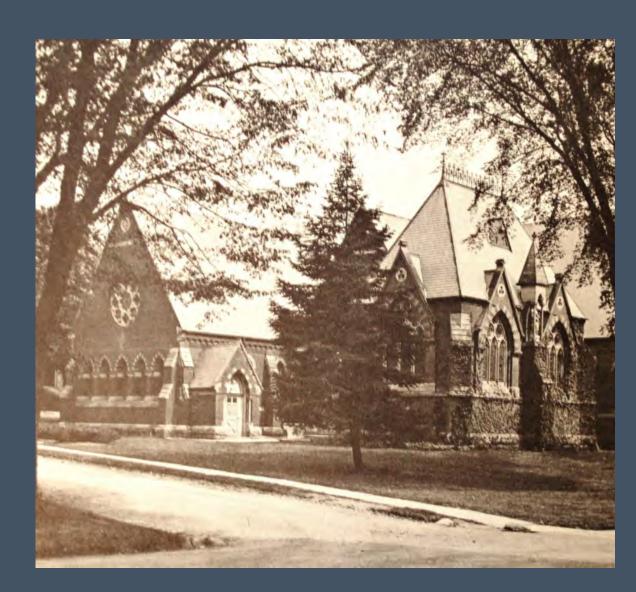

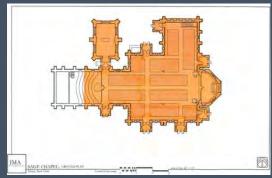

Chapel Evolution – 1940 Addition

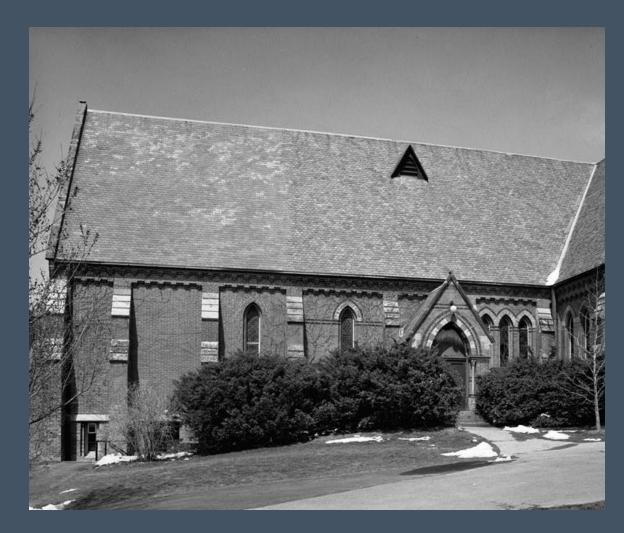

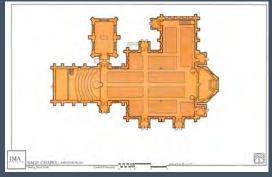

Chapel Evolution – Design Consistency



HABS Report: "The four additions made to the nave after 1880 demonstrate a remarkable concern to continuity of architectural design, of assuring that additions made over time contributed to a feeling of unity and harmony.

Memorial Chapel –

Visual Deficiencies:

Roof Conditions

Brick Masonry Conditions

Stone Masonry Conditions

Window Conditions

Memorial Chapel – Gable Rake (North Gable)



Memorial Chapel – Deteriorated Brick








Memorial Chapel – Slate at the end of its Service Life




Ribbon slate – life expectancy 100-120 years

Memorial Chapel – Misc. Details

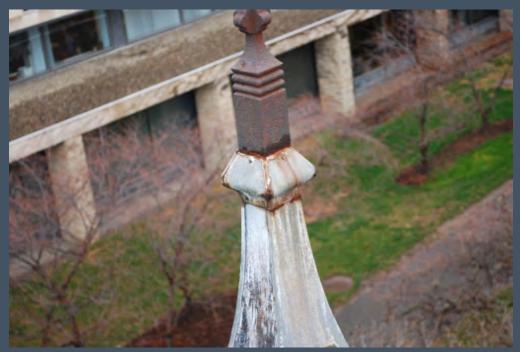

Finials

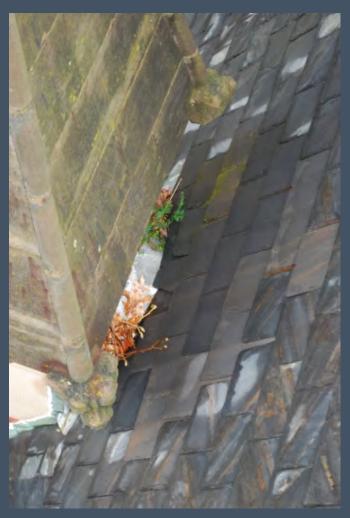

Behind tabernacles

Memorial Chapel – Roof Conditions





East & West Gables



Gutters – size, installation



Memorial Chapel – Stone Masonry Conditions











Memorial Chapel – Brick Masonry Conditions




Memorial Chapel – Brick Masonry Conditions








Apse of Main Building – Stained Glass Windows

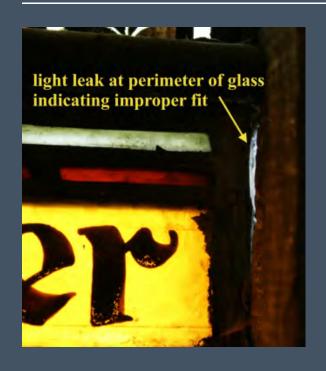

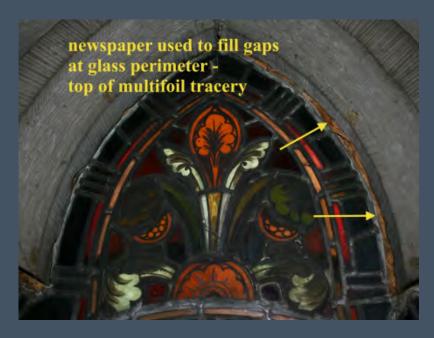





Sage Chapel Exterior Renovation of Memorial Chapel

Cornell University Ithaca, New York

for
Cornell University
Facilities Services

DRAWING INDEX


A101 Floor Plans
A102 Roof Plans
A103 Roof Details

A104 Main Chapel Apse Window Repair - Plan & Images


A201 East and North Elevations

A202 West Elevation


A301 East & West Building Sections
A302 North & South Building Sections

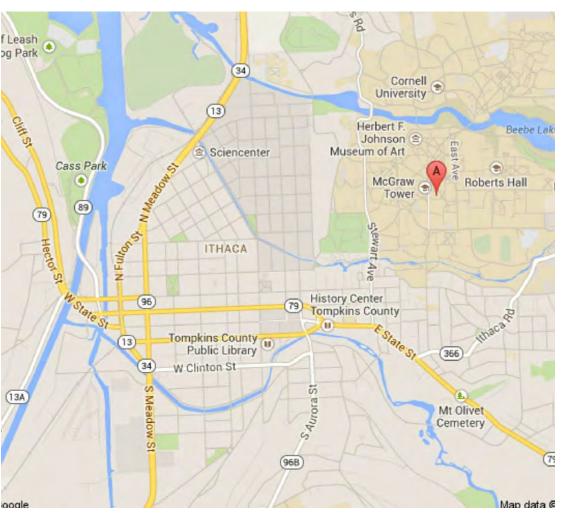

Area Map

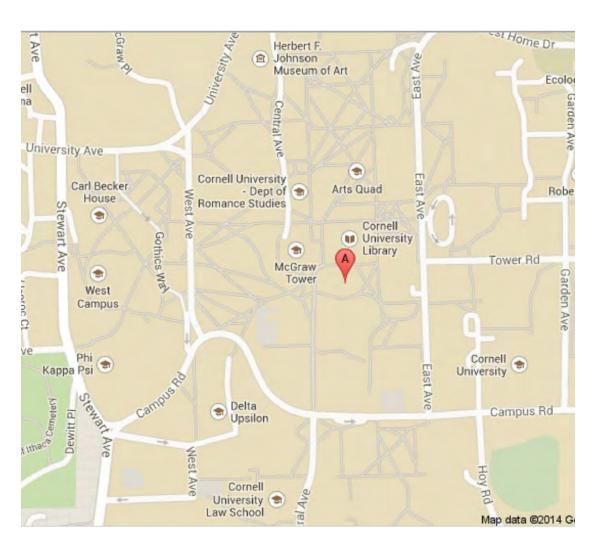


Campus Vicinty Map

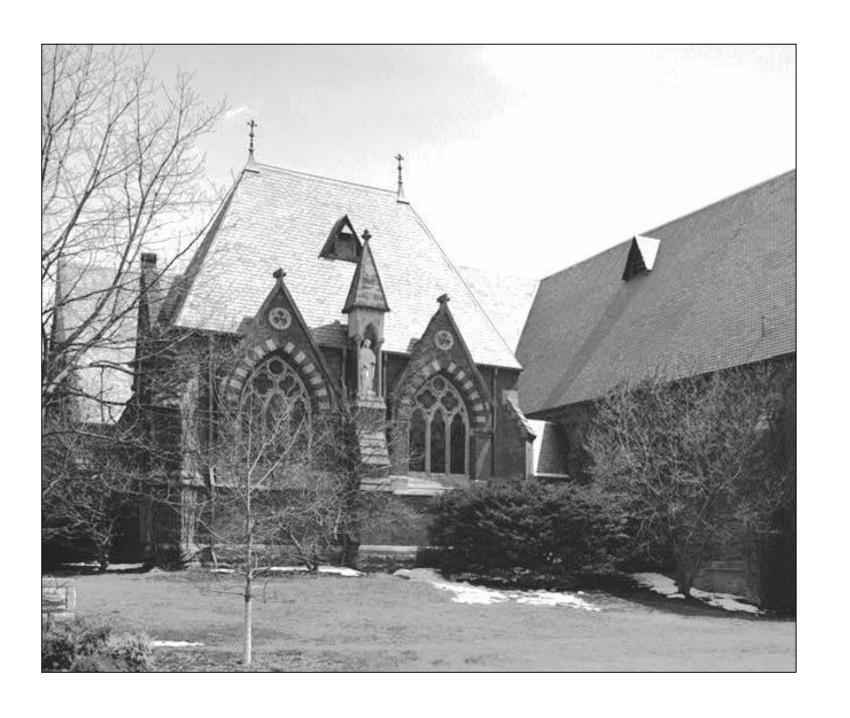

ARCHITECT
John Milner Associates, Inc.
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Alexandria, Virginia 22312
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www.johnmilnerassociates.com

STRUCTURAL ENGINEER
Robert Silman Associates, PC
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Boston, Massachusetts 02109
P: 617.695.6700
www.silman.com

Construction Documents
January 22, 2014

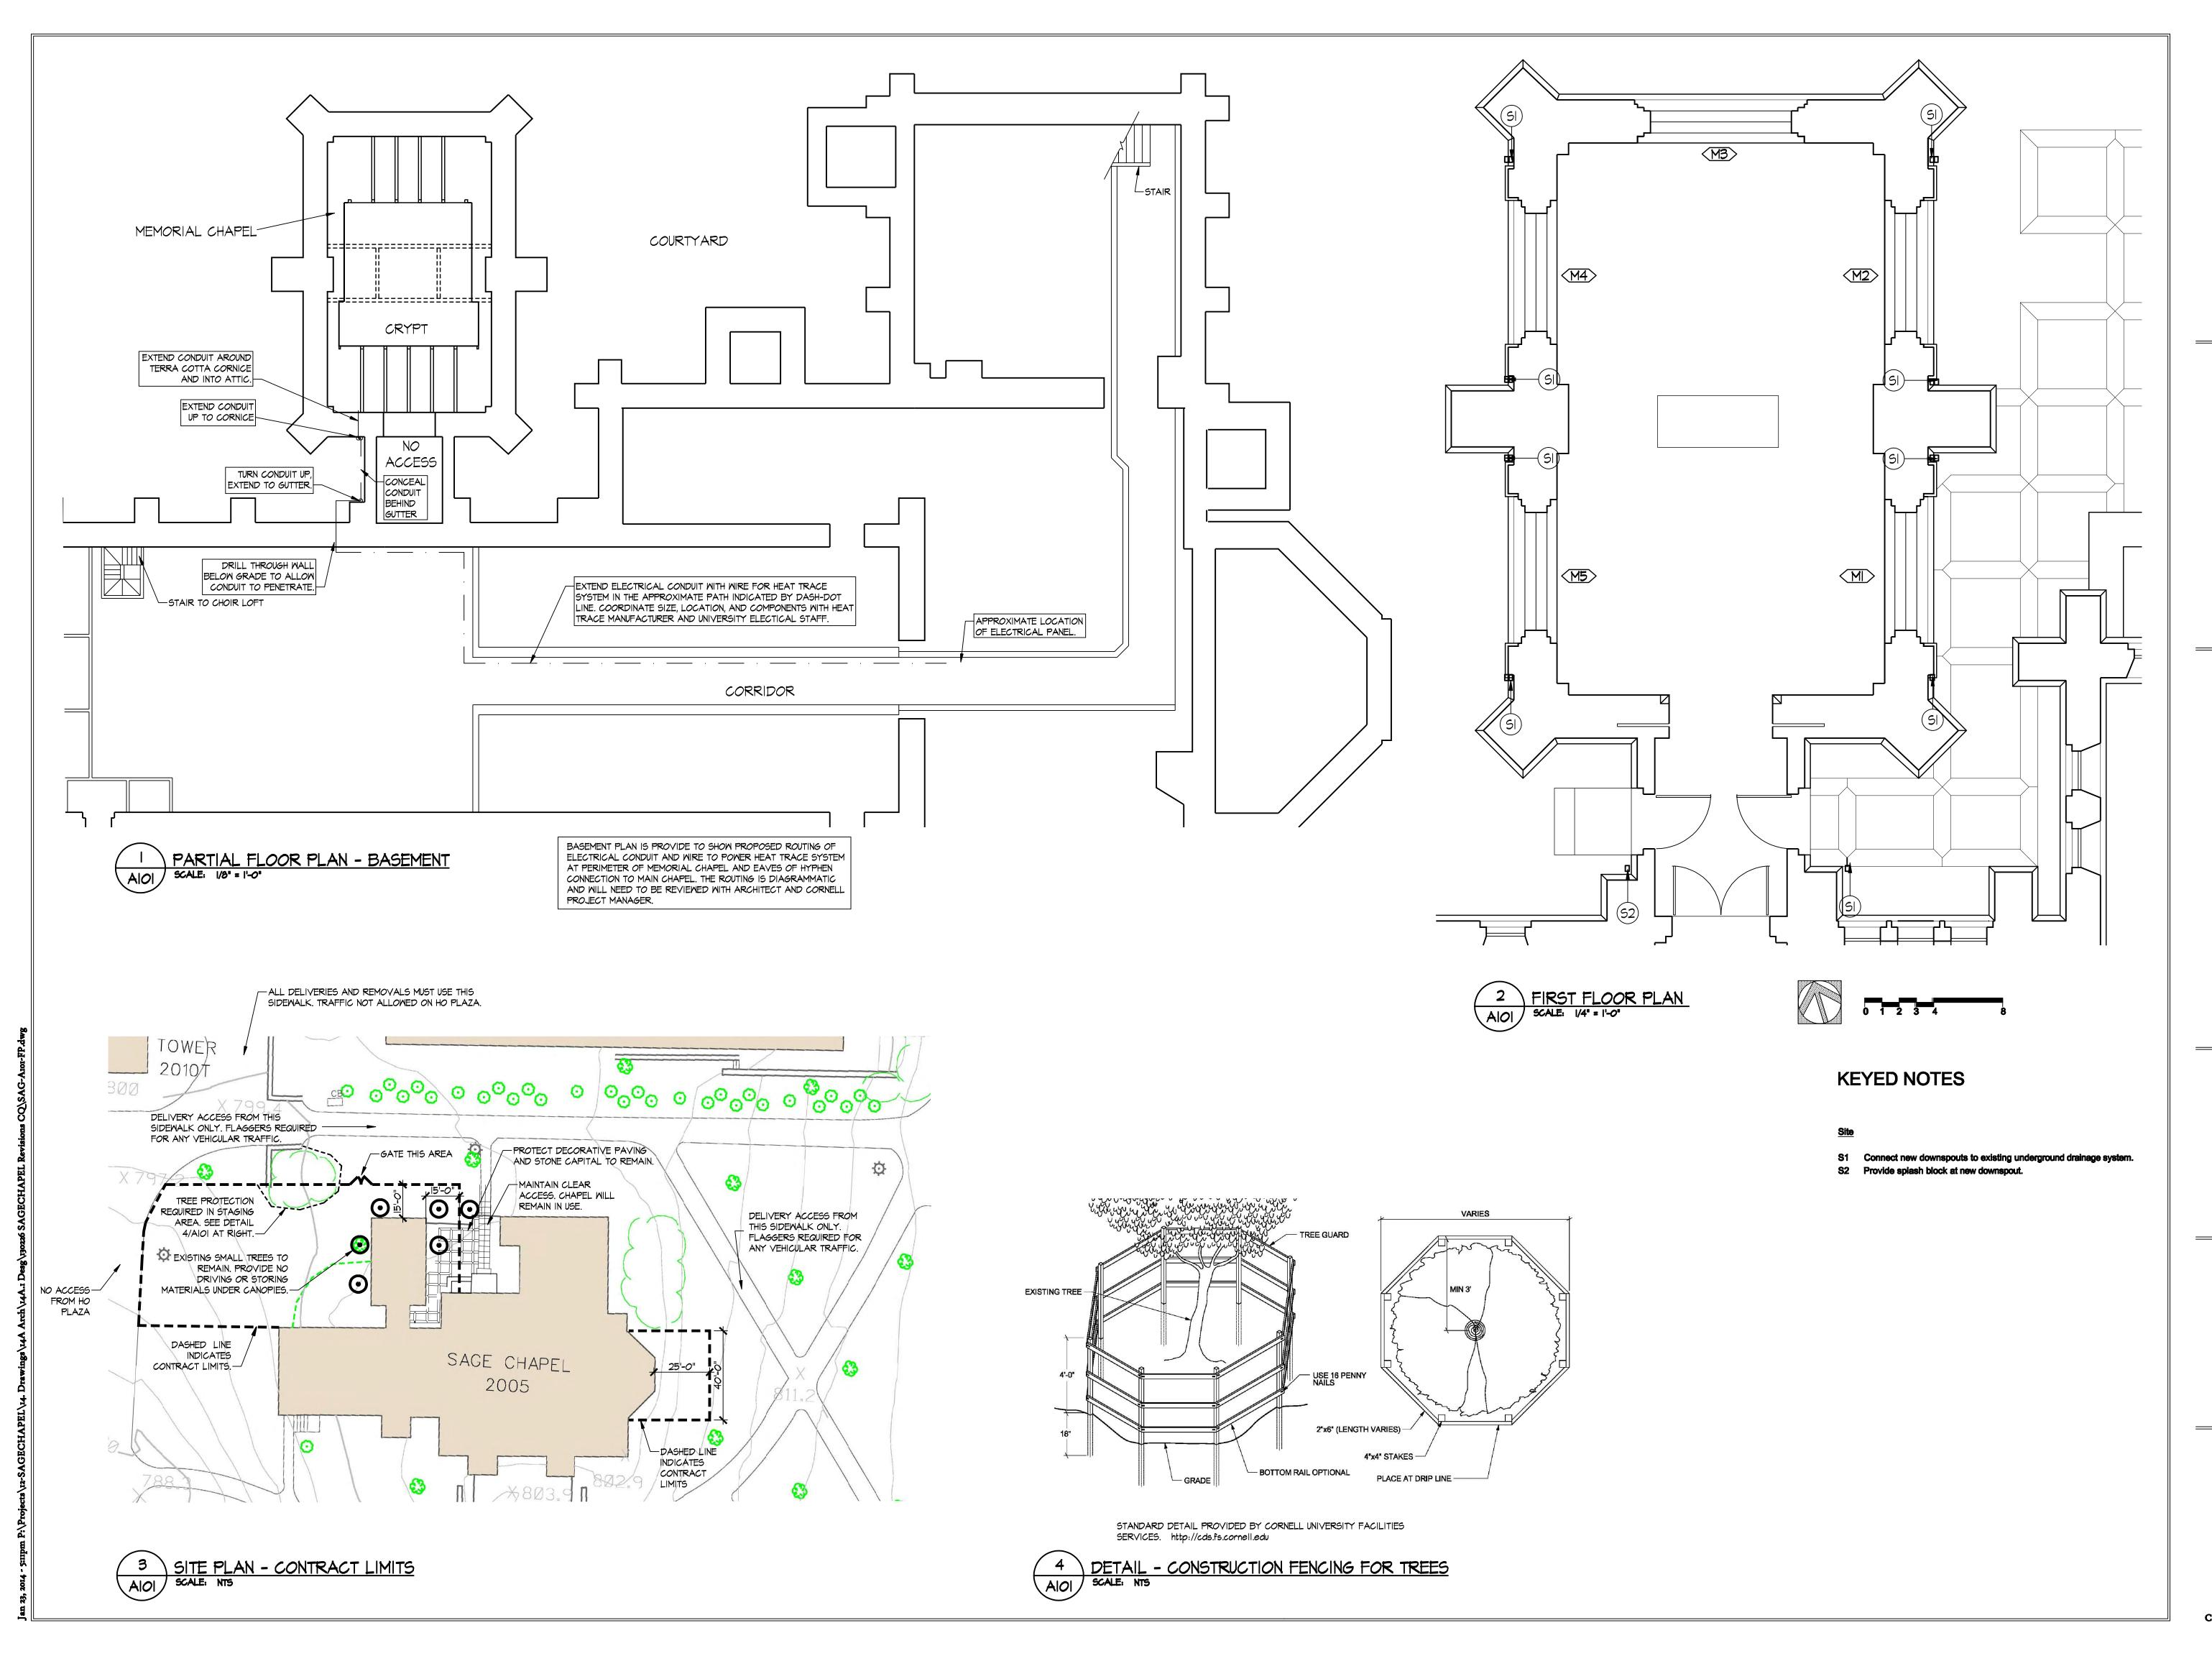

Sage Chapel

Exterior Renovation of Memorial

Chapel

for Cornell University Facilities Services Ithaca, New York



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t: 703 354 9737

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Structural Engineer
Robert Silman Associates
Boston, MA

CONSTRUCTION DOCUMENTS




project: SAGECHAPEL
drawn: JB, CQ
hecked: JM
phase: CDs
date: 22 January 2014

FLOOR PLANS

AIOI

NOT TO SCALE:
reduced size drawing

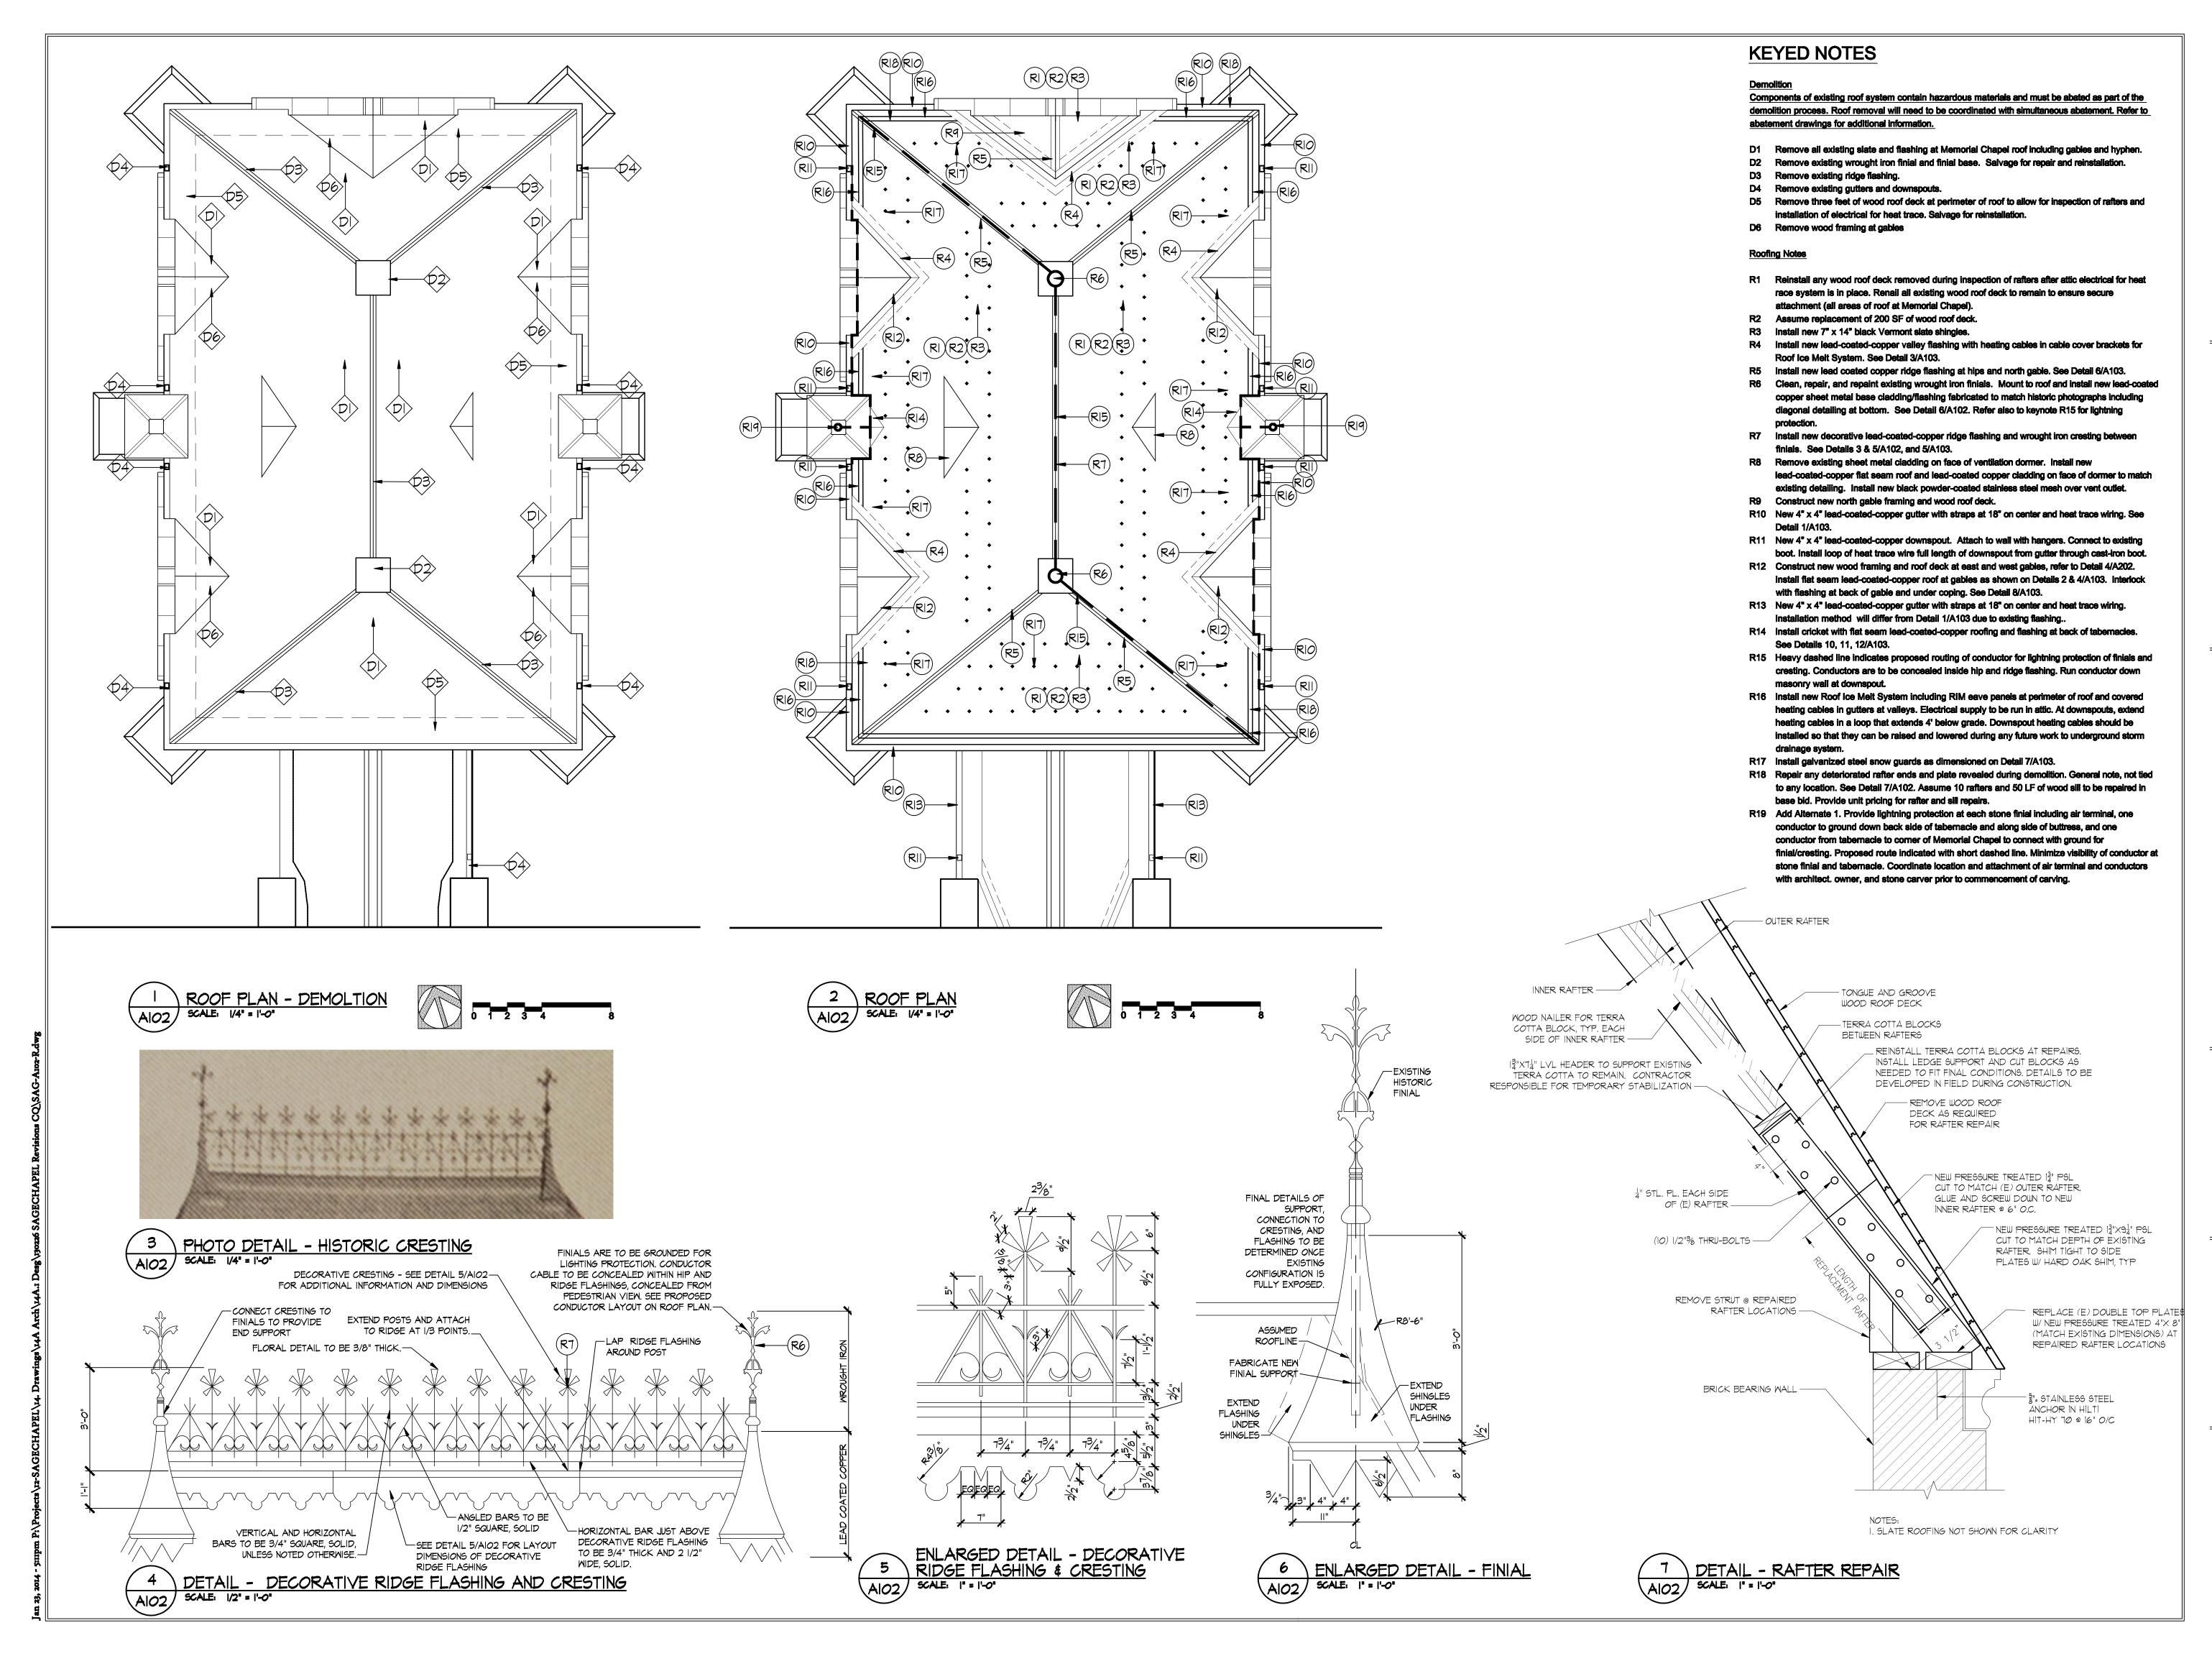

Sage Chapel

Exterior Renovation of Memorial

Chapel

for Cornell University Facilities Services Ithaca, New York

J M A John Milner Associates, Inc.

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iohnmilnerassociates.com

t: 703 354 9737

f: 703 642 1837

Boston, MA

Structural Engineer
Robert Silman Associates

CONSTRUCTION DOCUMENTS




project: SAGECHAPEL
drawn: JB, CQ
checked: JM
phase: CDs
date: 22 January 2014
revised:

ROOF

PLANS

A102

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Sage Chapel

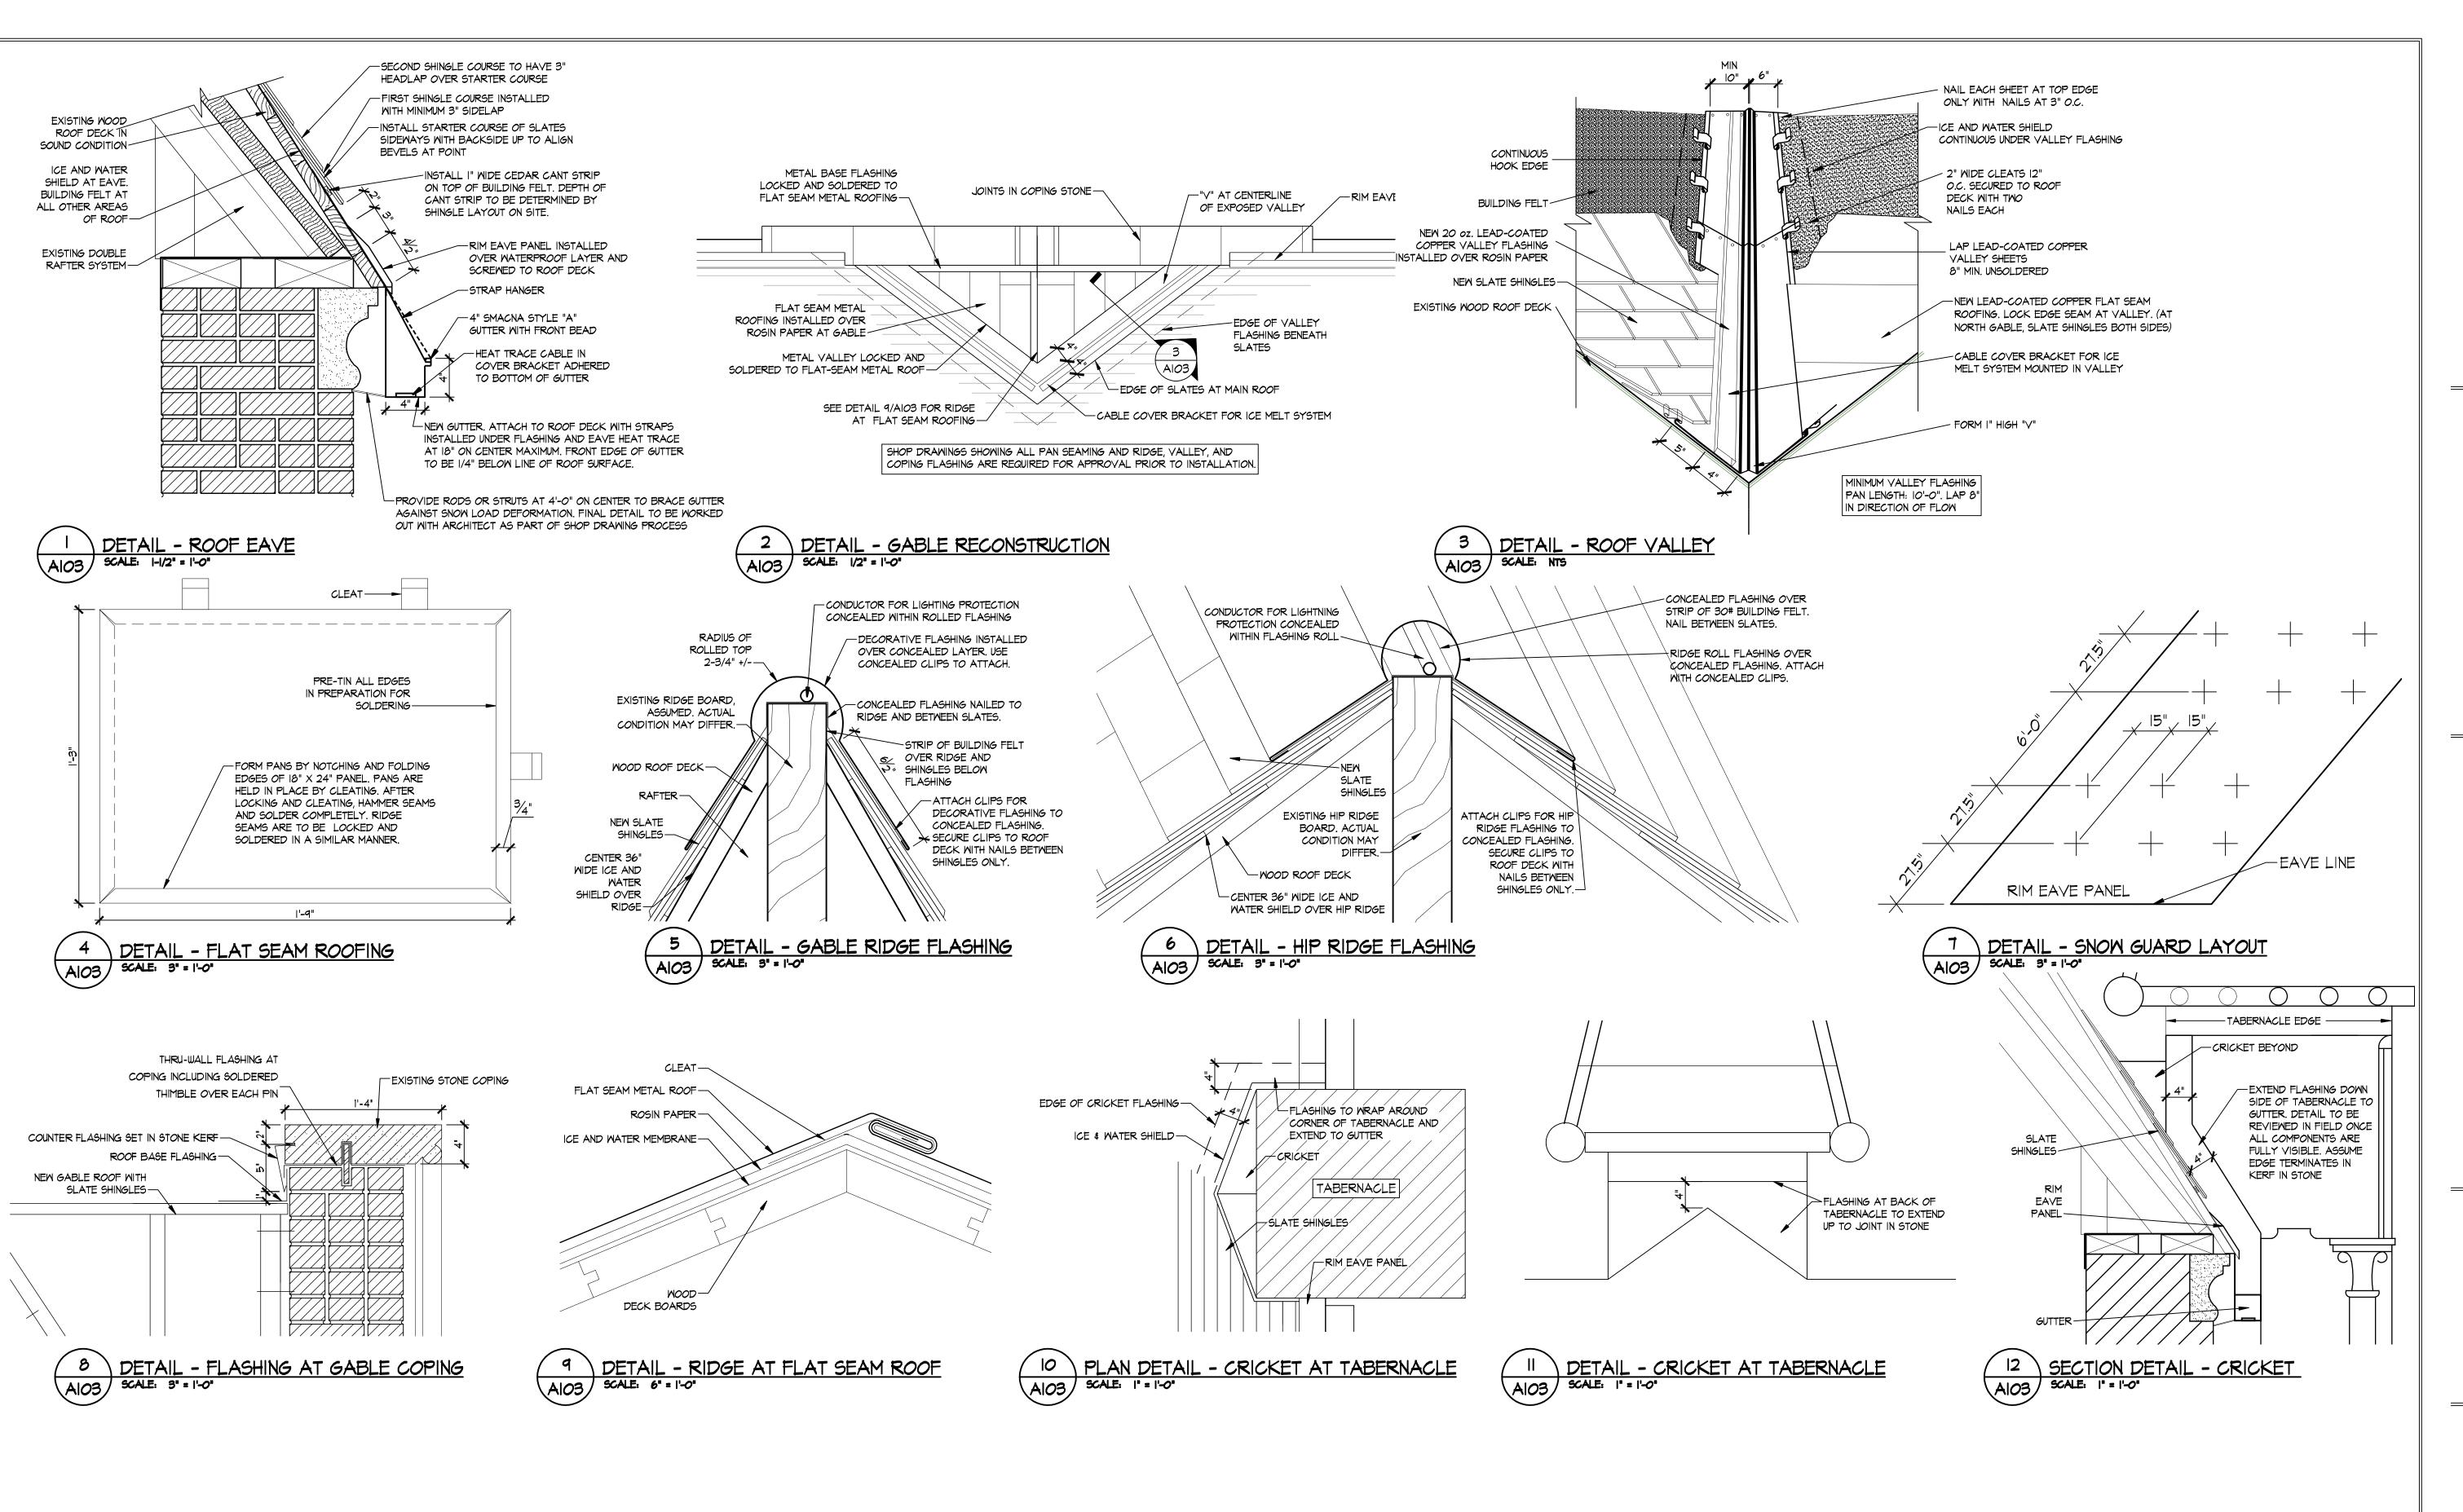Exterior Renovation of Memorial

Chapel

for Cornell University Facilities Services Ithaca, New York



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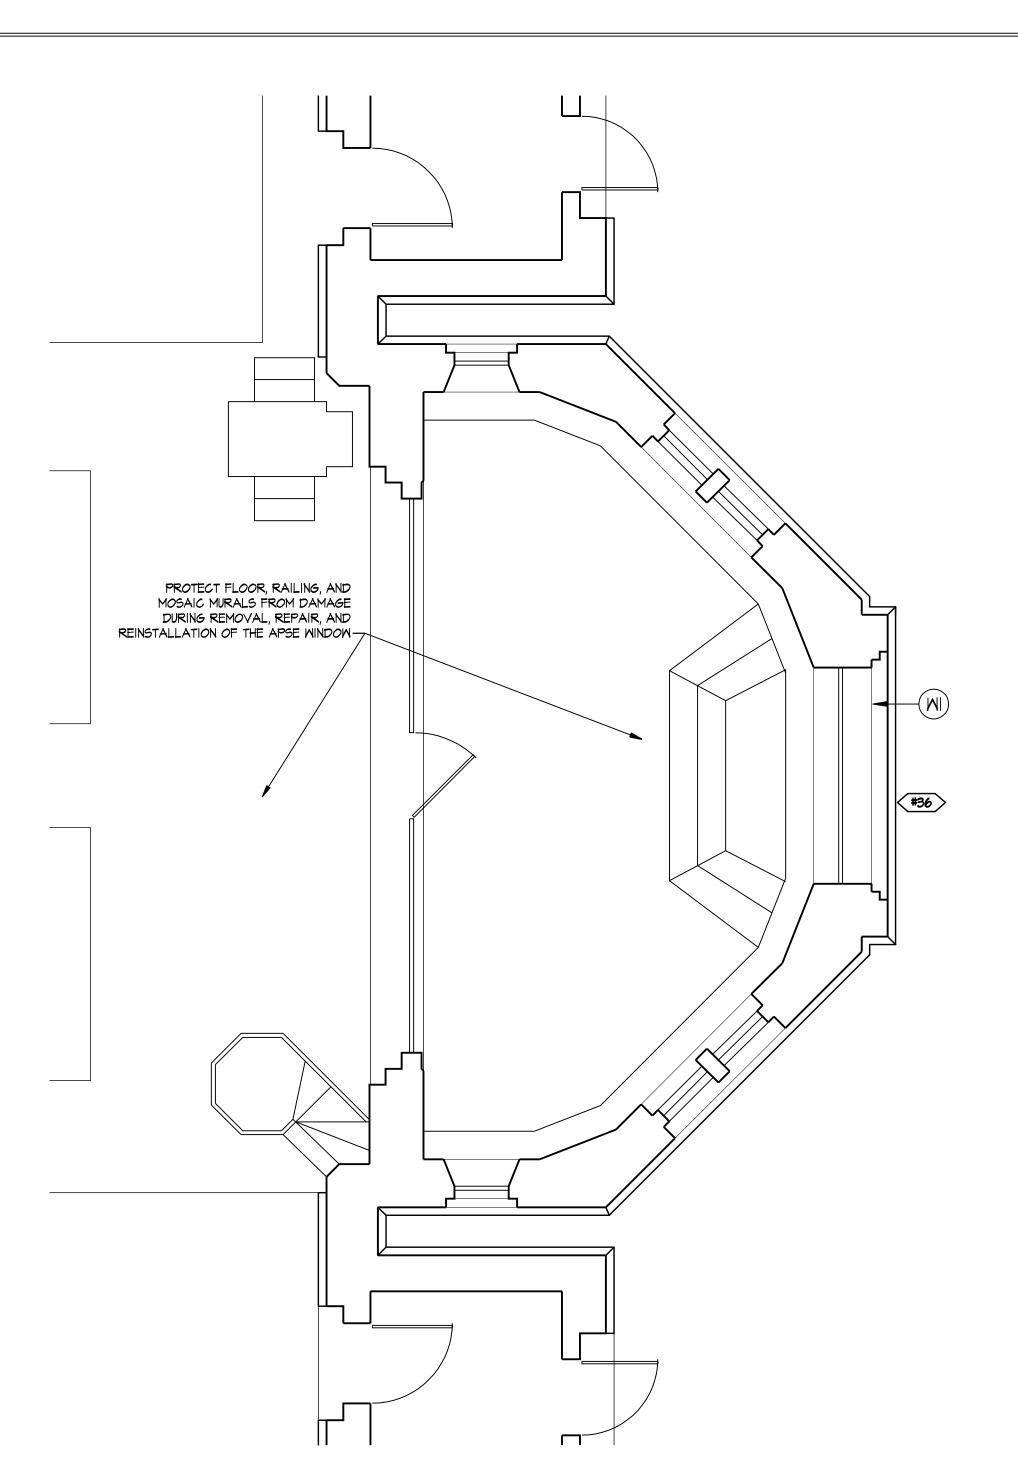
CONSTRUCTION DOCUMENTS




project: SAGECHAPEL
drawn: JB, CQ
checked: JM
phase: CDs
date: 22 January 2014
revised:

ROOF DETAILS

A103






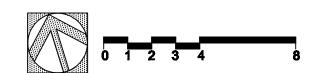



2 EXTERIOR VIEW - APSE AT MAIN CHAPEL AIO4 SCALE: NTS

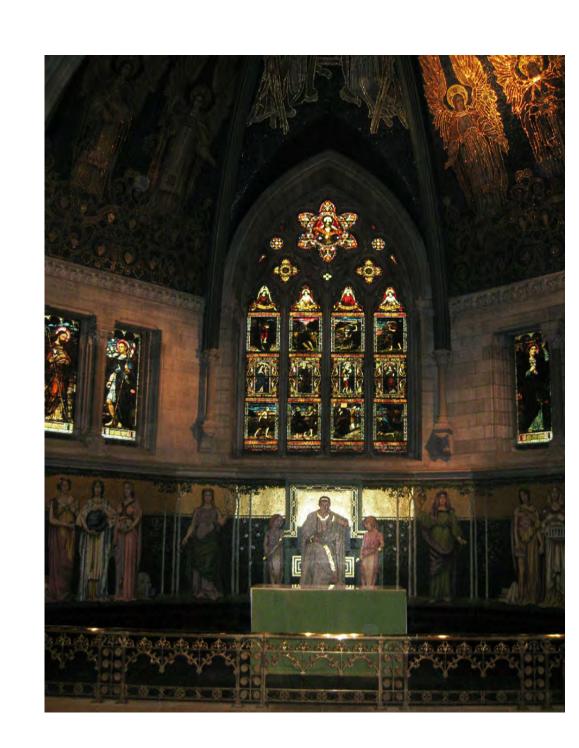



KEYED NOTES

The first section of notes applies to the area defined as the limit of work on the apse window elevation and, as a result, the notes are not keyed to the drawings.

MS1 Clean all stone at tracery, this facade only.

The remainder of the keyed notes apply to all areas of work. Because notes address work on more than one facade, quantities indicated are totals for all facades, unless noted otherwise.

Repair all cracked bricks. No repair at hairline cracks. In situ repair of minor cracks. Assume 34 MS19 Remove 2 lead anchors in joint between stone and brick. Repoint joint. bricks. Replace bricks at major cracks, assume 7 bricks.

After stained glass is removed, dismantle four stone tracery units in the window opening inside Windows the work area as shown, but leave the perimeter stones in place. Clean sealant from joints. Reinstall stone tracery, installing stainless steel pins to secure joints. See Detail3/A202. Patch W1 any stone that is holding water at joints. At joint between stone tracery and brick, remove sealant and install new sealant with sanded finish to match masonry joints.


Remove all existing patches at holes and at joints in stone tracery at exterior of apse window in Main Chapel. Install new patches to match stone. Approximately 95 holes and 10 joints. After stained glass is removed, clean all sealant from stone tracery at perimeter of each window

opening in tracery. At Main Chapel apse window, remove any visible wood shims and ferrous nails used at joints in stone tracery. Repoint all joints in stone tracery.

MS18 Install dutchman repair at damaged stone tracery. Size of dutchman noted at keyed note. MS20 Remove deteriorated stone and prepare for patching. Install stone patch to match color, strength, and texture of historic stone. Architect to inspect prepared stone prior to patching.

Remove all leaded glass panels and fixed protective glazing from the entire window opening. Install temporary closure in openings. Restore window panels including cleaning, repair of cracked and damaged glass, and 100% releading. Reinstall window panels when stone tracery has been restored. Modify fixed protective glazing to accommodate venting and reinstall.



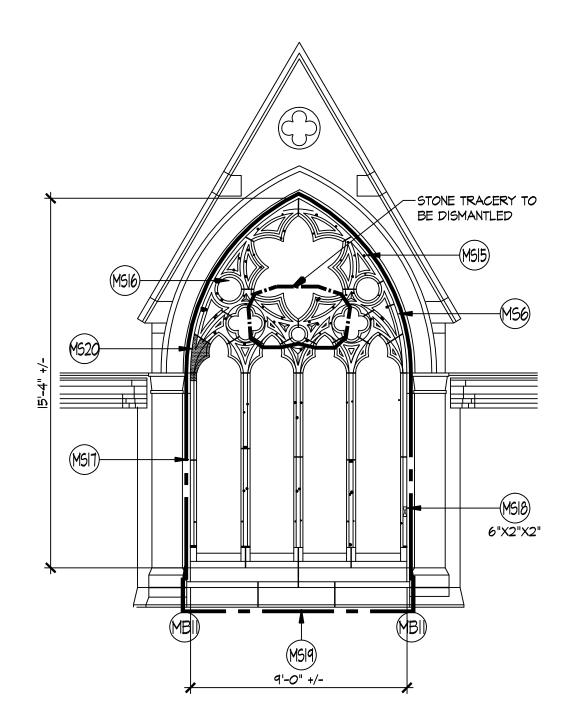

4 ELEVATION - APSE WINDOW AIO4 SCALE: 1/4" = 1'-0"

Sage Chapel Exterior Renovation of Memorial Chapel

> Cornell University Facilities Services Ithaca, New York



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CONSTRUCTION **DOCUMENTS**




SAGECHAPEL

MAIN CHAPEL APSE WINDOW REPAIR **PLAN & IMAGES**


NOT TO SCALE: reduced size drawing

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Demolition	

D13 Remove insect nest in stone trefoil.

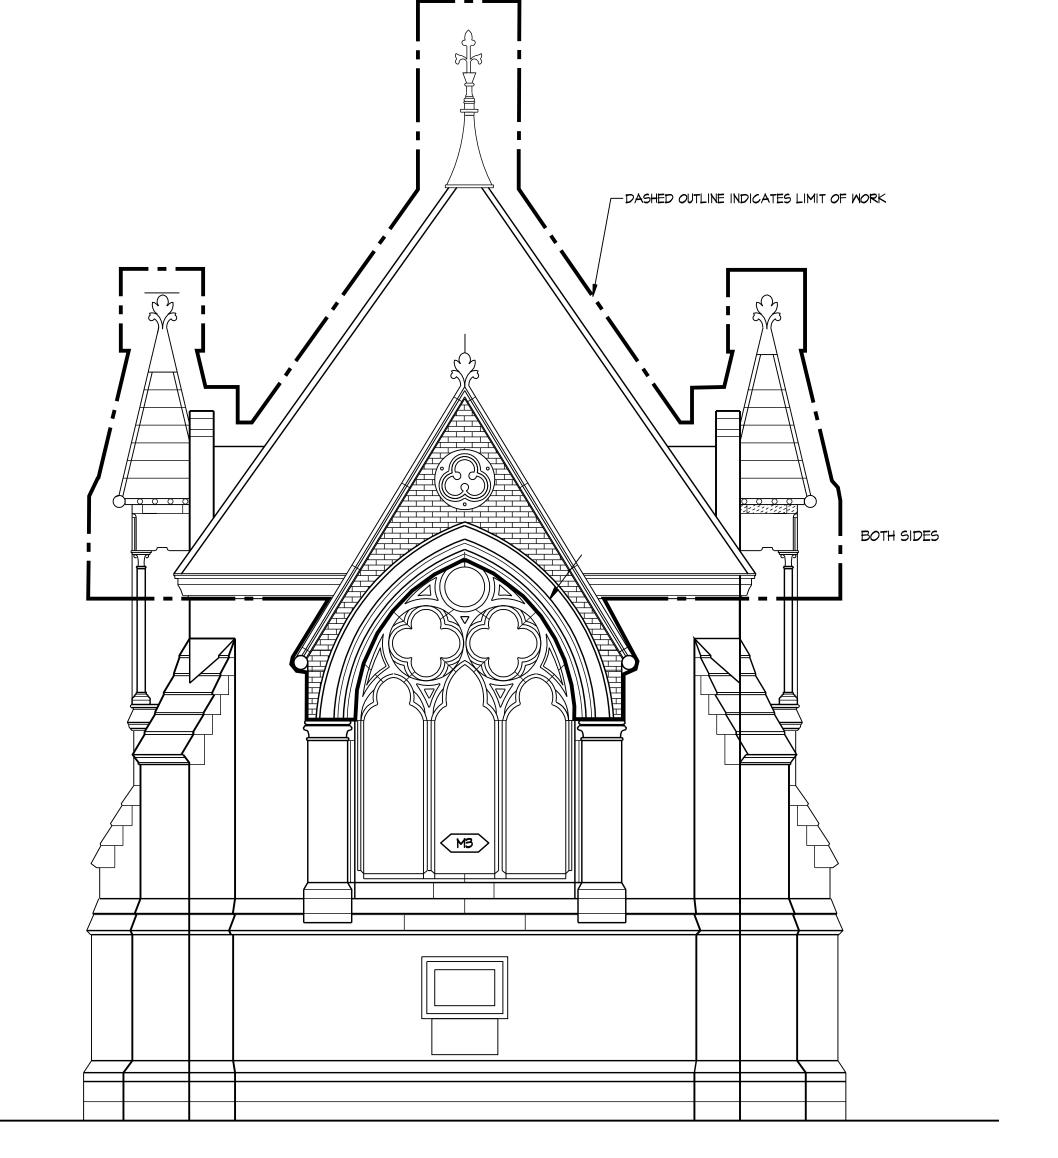- MB1 Repoint exterior of building brick 100% inside work area defined on elevation. Match existing
- Note that buff brick is pointed with buff mortar, red and black brick with red mortar. Clean all brick inside work area defined on elevation. Test cleaning methods on black, buff, and MS12 Remove eroded portion of stone. Install Dutchman repair. red brick before proceeding with overall cleaning.
- situ repair of minor cracks assume 34 bricks. Replace bricks at major cracks, assume 7 bricks Clean all stone inside work area defined on elevation.
- stones, repoint with mortar. Repoint all open stone and stone/brick joints with mortar. Assume 60 LF at comice. 5 LF at gable roundels. 60 LF at side of gable extensions in to brick.

The remainder of the keyed notes apply to all areas of work. Because notes address work on more than one facade, quantities indicated are totals for all facades, unless noted otherwise.

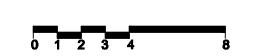- with a breathable masonry coating. Assume patching of 55 black bricks. Maintain colored mortar
- Clean efflorescence from wall prior to brick cleaning in area shown.
- After removal of stone cap, salvage existing face brick and repair deteriorated structural brick backup. Assume repair to be in all areas shown with brick hatch, full thickness of wall. See Detail 4/A202 for additional information. Reinstall face brick (narrow joints) and tie to structural brick backup with stainless steel "Z" ties. Replace any deteriorated bricks.

Remove all stone coping. Install 3 pins in each stone. Install flashing across top of masonry wall including cap at each pin. Thru-wall flashing must interlock with roof flashing at back of parapet. See Details 4 & 7/A202. Reinstall stone coping. Repoint with mortar, but close top of joint with sealant and lead strip as shown in Detail 8/A202. Remove stacked stone layers of tabernacle roof. Replace ferrous pipe dowel in center of stone

with stainless steel pipe. Install flashing at joint in lowest full stone layer. Reinstall stone layers. MS10 Test cleaning approach on east tabernacle stone statue. Clean statue. MS11 Install missing finial stone at tabernacle roof. Two stones required. Carve to match historic using photographic documentation. See photo Detail 4/A201.See Roof Keyed Note R-19 for lightning

Clean, repair, and repaint existing wrought iron finials. Mount to new lead-coated copper bases fabricated to match historic photographs including diagonal detailing at bottom. See Detail 5/A102. See also Roof Plan Keyed Note R-15 for lightning protection.

Install new decorative lead coated copper ridge flashing and wrought iron cresting between

finials. See Detail 5/102 and Detail 6/102. Remove existing sheet metal cladding on face of ventilation dormer. Install new lead coated

copper cladding on face of dormer to match existing detailing. Install new black powder-coated stainless steel mesh over vent outlet.

KEYED NOTES

The following section of notes applies to the east elevation and north elevation within the designated limits MS8 of work, and as a result, these notes are not keyed to the drawings.

mortar color, strength, and texture.

Repair all cracked bricks inside work area defined on elevation. No repairs at hairline cracks. In Roof

Remove any sealant at joints between stone and brick, terra cotta and brick, and between

- Remove any brick coating at black bricks. Patch any spalled black bricks. Repaint black bricks at joints, do not paint over.
- Replace eroded or spalled bricks. Match existing brick color, size, texture, and strength.
- Assume replacement of 145 bricks.
- MB10 Replace deteriorated or spalled special shape bricks at edge of arch. See table this sheet for quantities of each shape and color.

EAST & NORTH

ELEVATIONS

SAGECHAPEL

XX

Sage Chapel

Memorial

Cornell University Facilities Services Ithaca, New York

5250 Cherokee Avenue

Alexandria, Virginia 22312

johnmilnerassociates.com

Robert Silman Associates

CONSTRUCTION

DOCUMENTS

Third Floor

t: 703 354 9737 f: 703 642 1837

Boston, MA

Chapel

Exterior Renovation of










-FINIAL IS THREE DIMENSIONAL, SHOWN

HERE IN SIMPLIFIED FORM.

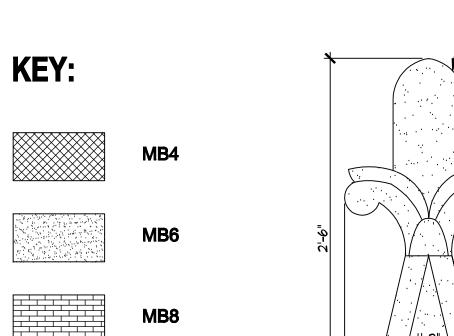

MS12

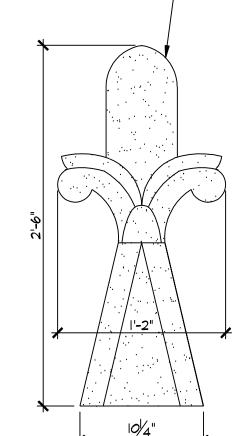

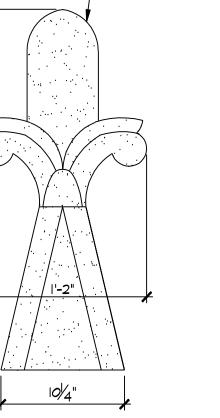








SPECIAL SHAPE BRICKS AT ARCHES												
	WINDOW W1 (SE)				WINDOW W2 (NE)				WINDOW W3 (NORTH)			
KEY#	1	2	3	4	1	2	3	4	1	2	3	4
RED	_	1	_	4	_	_	_	_	_	1	1	7
BUFF	3	3	1	1	_	1	_	_	3	4	_	_



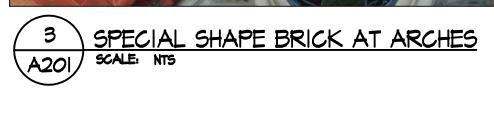

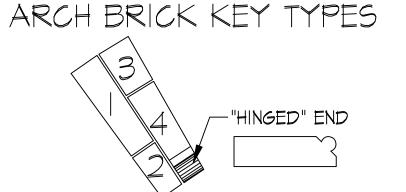

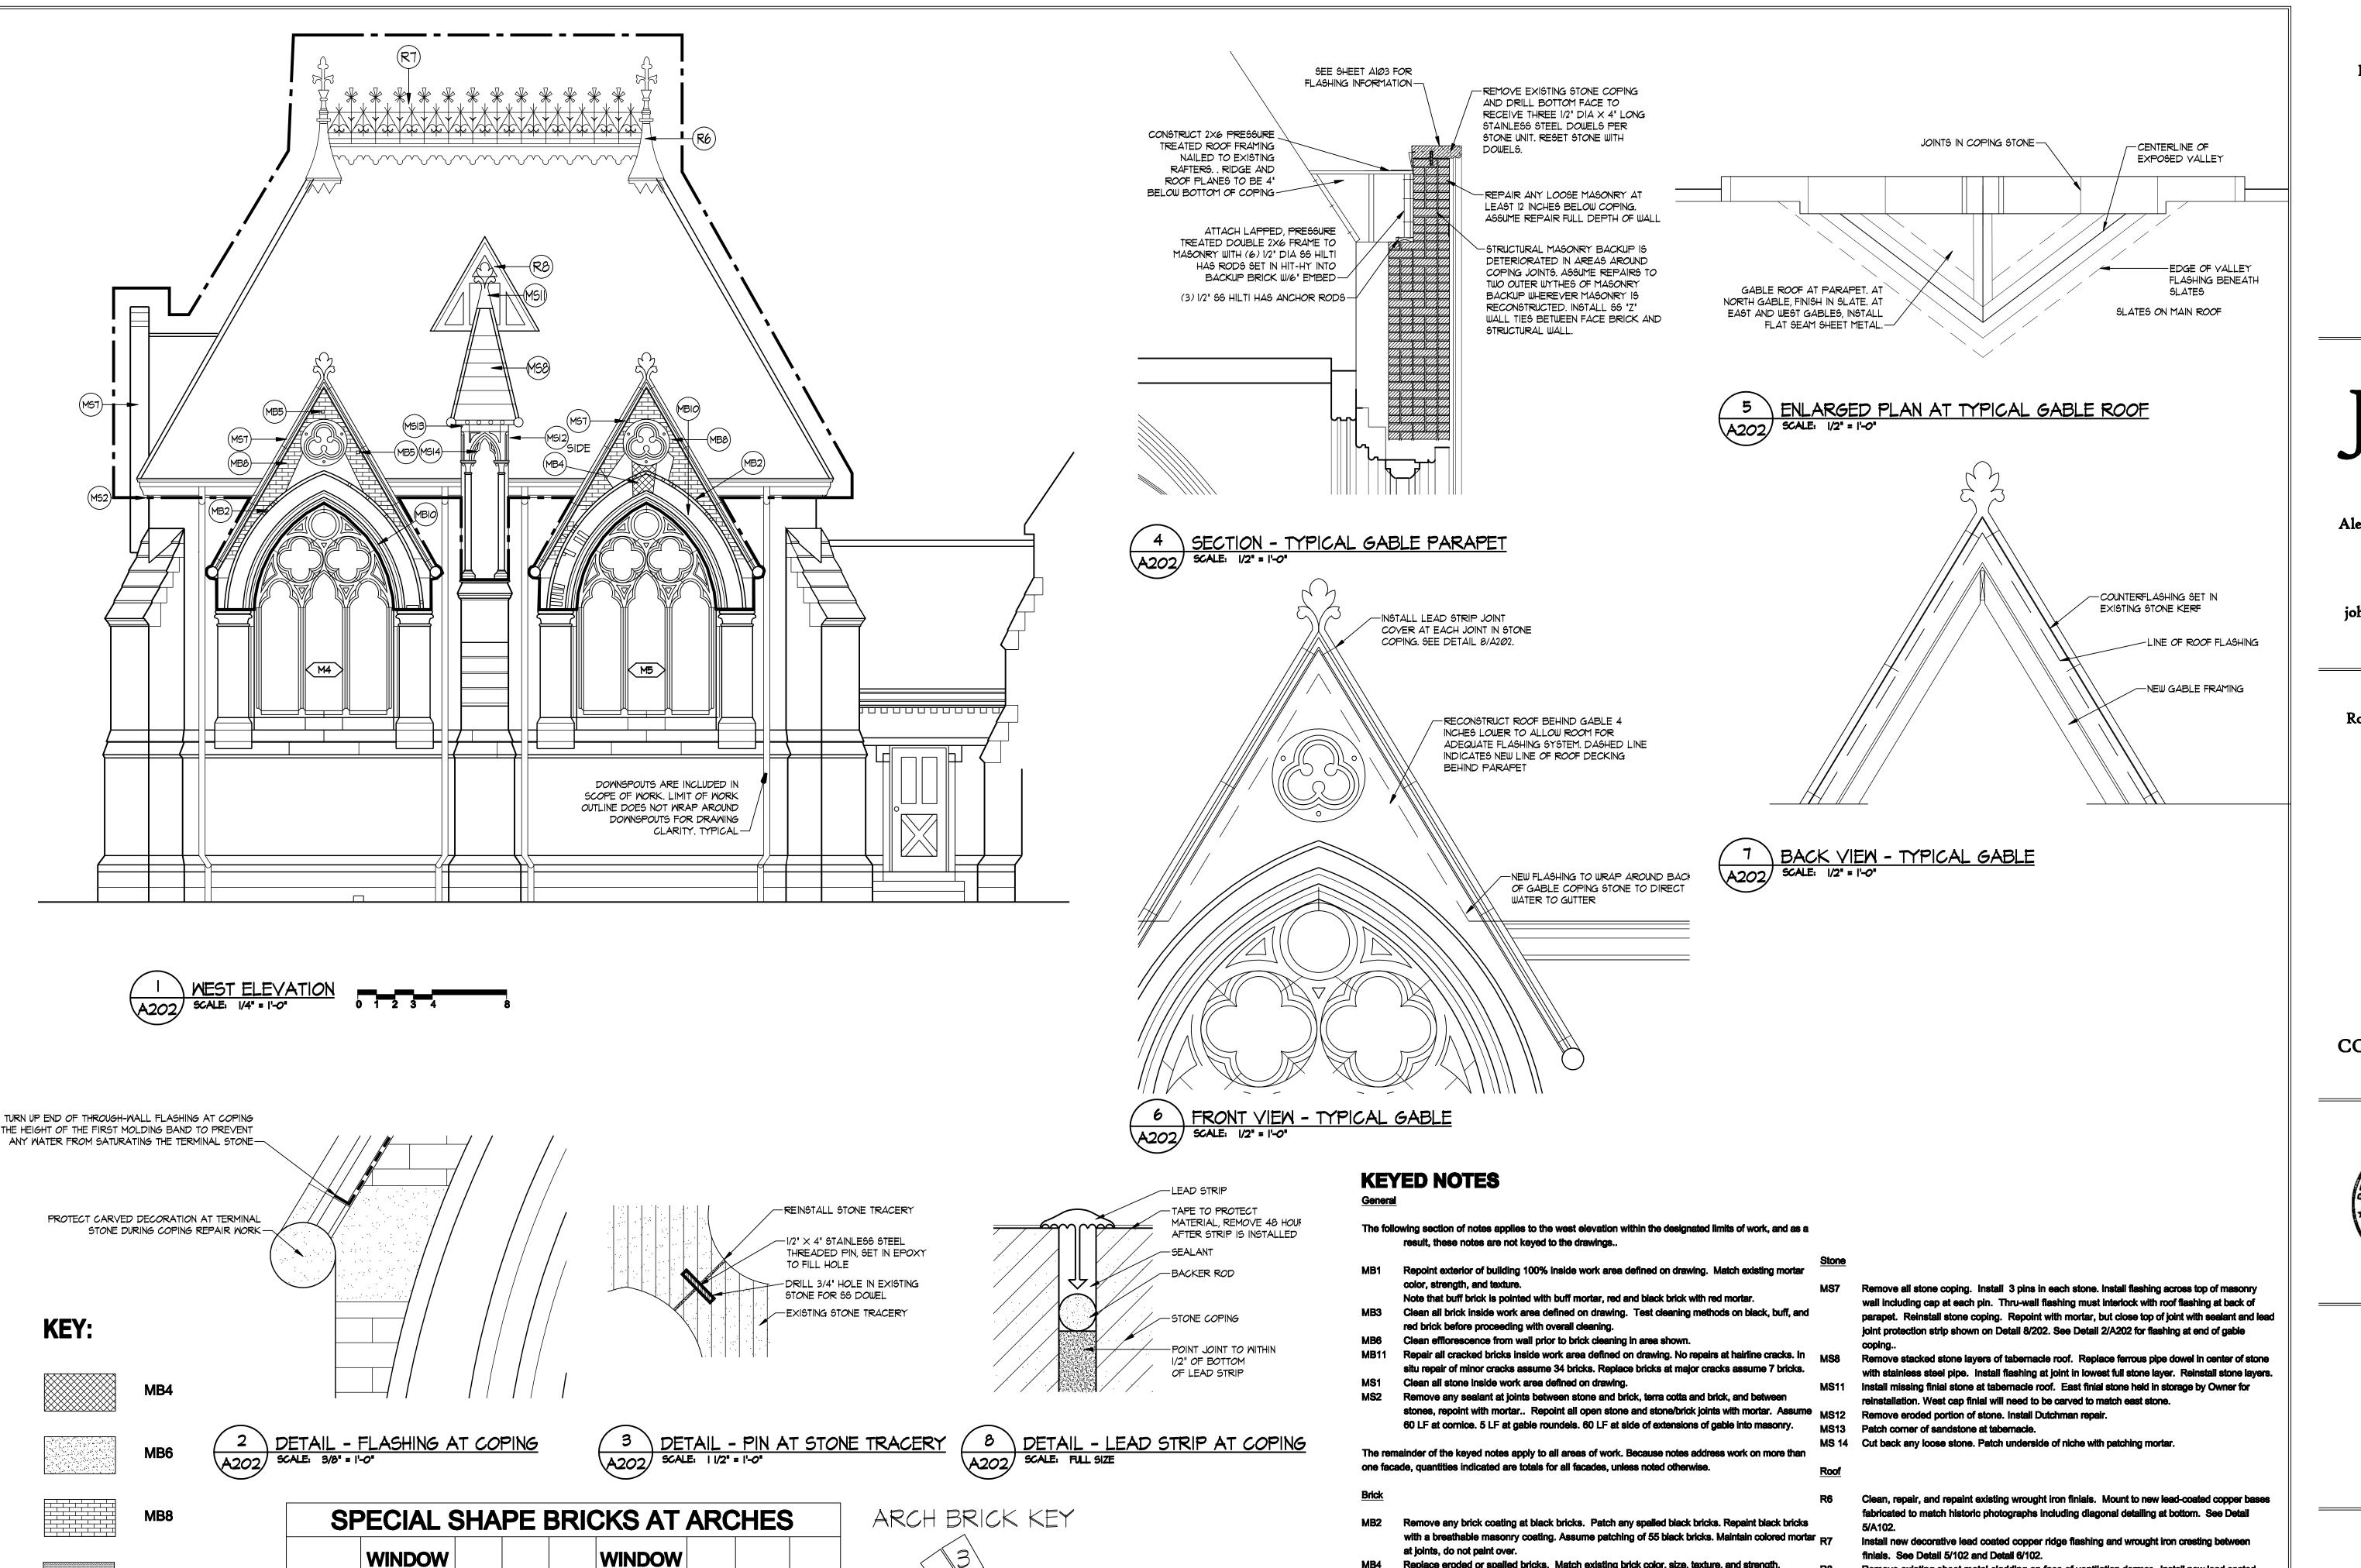

-"HINGED" END

SEE ALSO DETAIL 3/A201 FOR

PHOTO OF SPECIAL SHAPE BRICKS

W4 (NW)

W5 (SW)

KEY

RED

BUFF

MS12

Replace eroded or spalled bricks. Match existing brick color, size, texture, and strength.

MB10 Replace deteriorated or spalled special shape bricks at edge of arch. See table this sheet for

After removal of stone cap, salvage existing face brick and repair deteriorated structural brick

backup. Assume repair to be in all areas shown with brick hatch, full thickness of wall. See Detail 4/A202 for additional information. Reinstall face brick (narrow joints) and tie to structural brick

Replace previously patched bricks. Assume replacement of 45 bricks.

backup with stainless steel "Z" ties. Replace any deteriorated bricks.

Assume replacement of 145 bricks.

quantities of each shape and color.

Sage Chapel Exterior Renovation of Memorial Chapel

> Cornell University Facilities Services Ithaca, New York

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t: 703 354 9737

johnmilnerassociates.com

Structural Engineer Robert Silman Associates Boston, MA

CONSTRUCTION **DOCUMENTS**



project:	SAGECHAPEL
drawn:	JB, CQ
checked:	JM
phase:	CDa
date:	22 January 2014
revised:	

WEST **ELEVATION**

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Remove existing sheet metal cladding on face of ventilation dormer. Install new lead coated

stainless steel mesh over vent outlet.

copper cladding on face of dormer to match existing detailing. Install new black powder-coated



Sage Chapel

Exterior Renovation of Memorial Chapel

for Cornell University Facilities Services Ithaca, New York

JMA John Milner Associates, Inc.

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Structural Engineer
Robert Silman Associates
Boston, MA

CONSTRUCTION DOCUMENTS




project: SAGECHAP:
drawn: JB, C
checked: J
phase: C
date: 22 January 26

EAST & WEST BUILDING SECTIONS

A301

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Sage Chapel

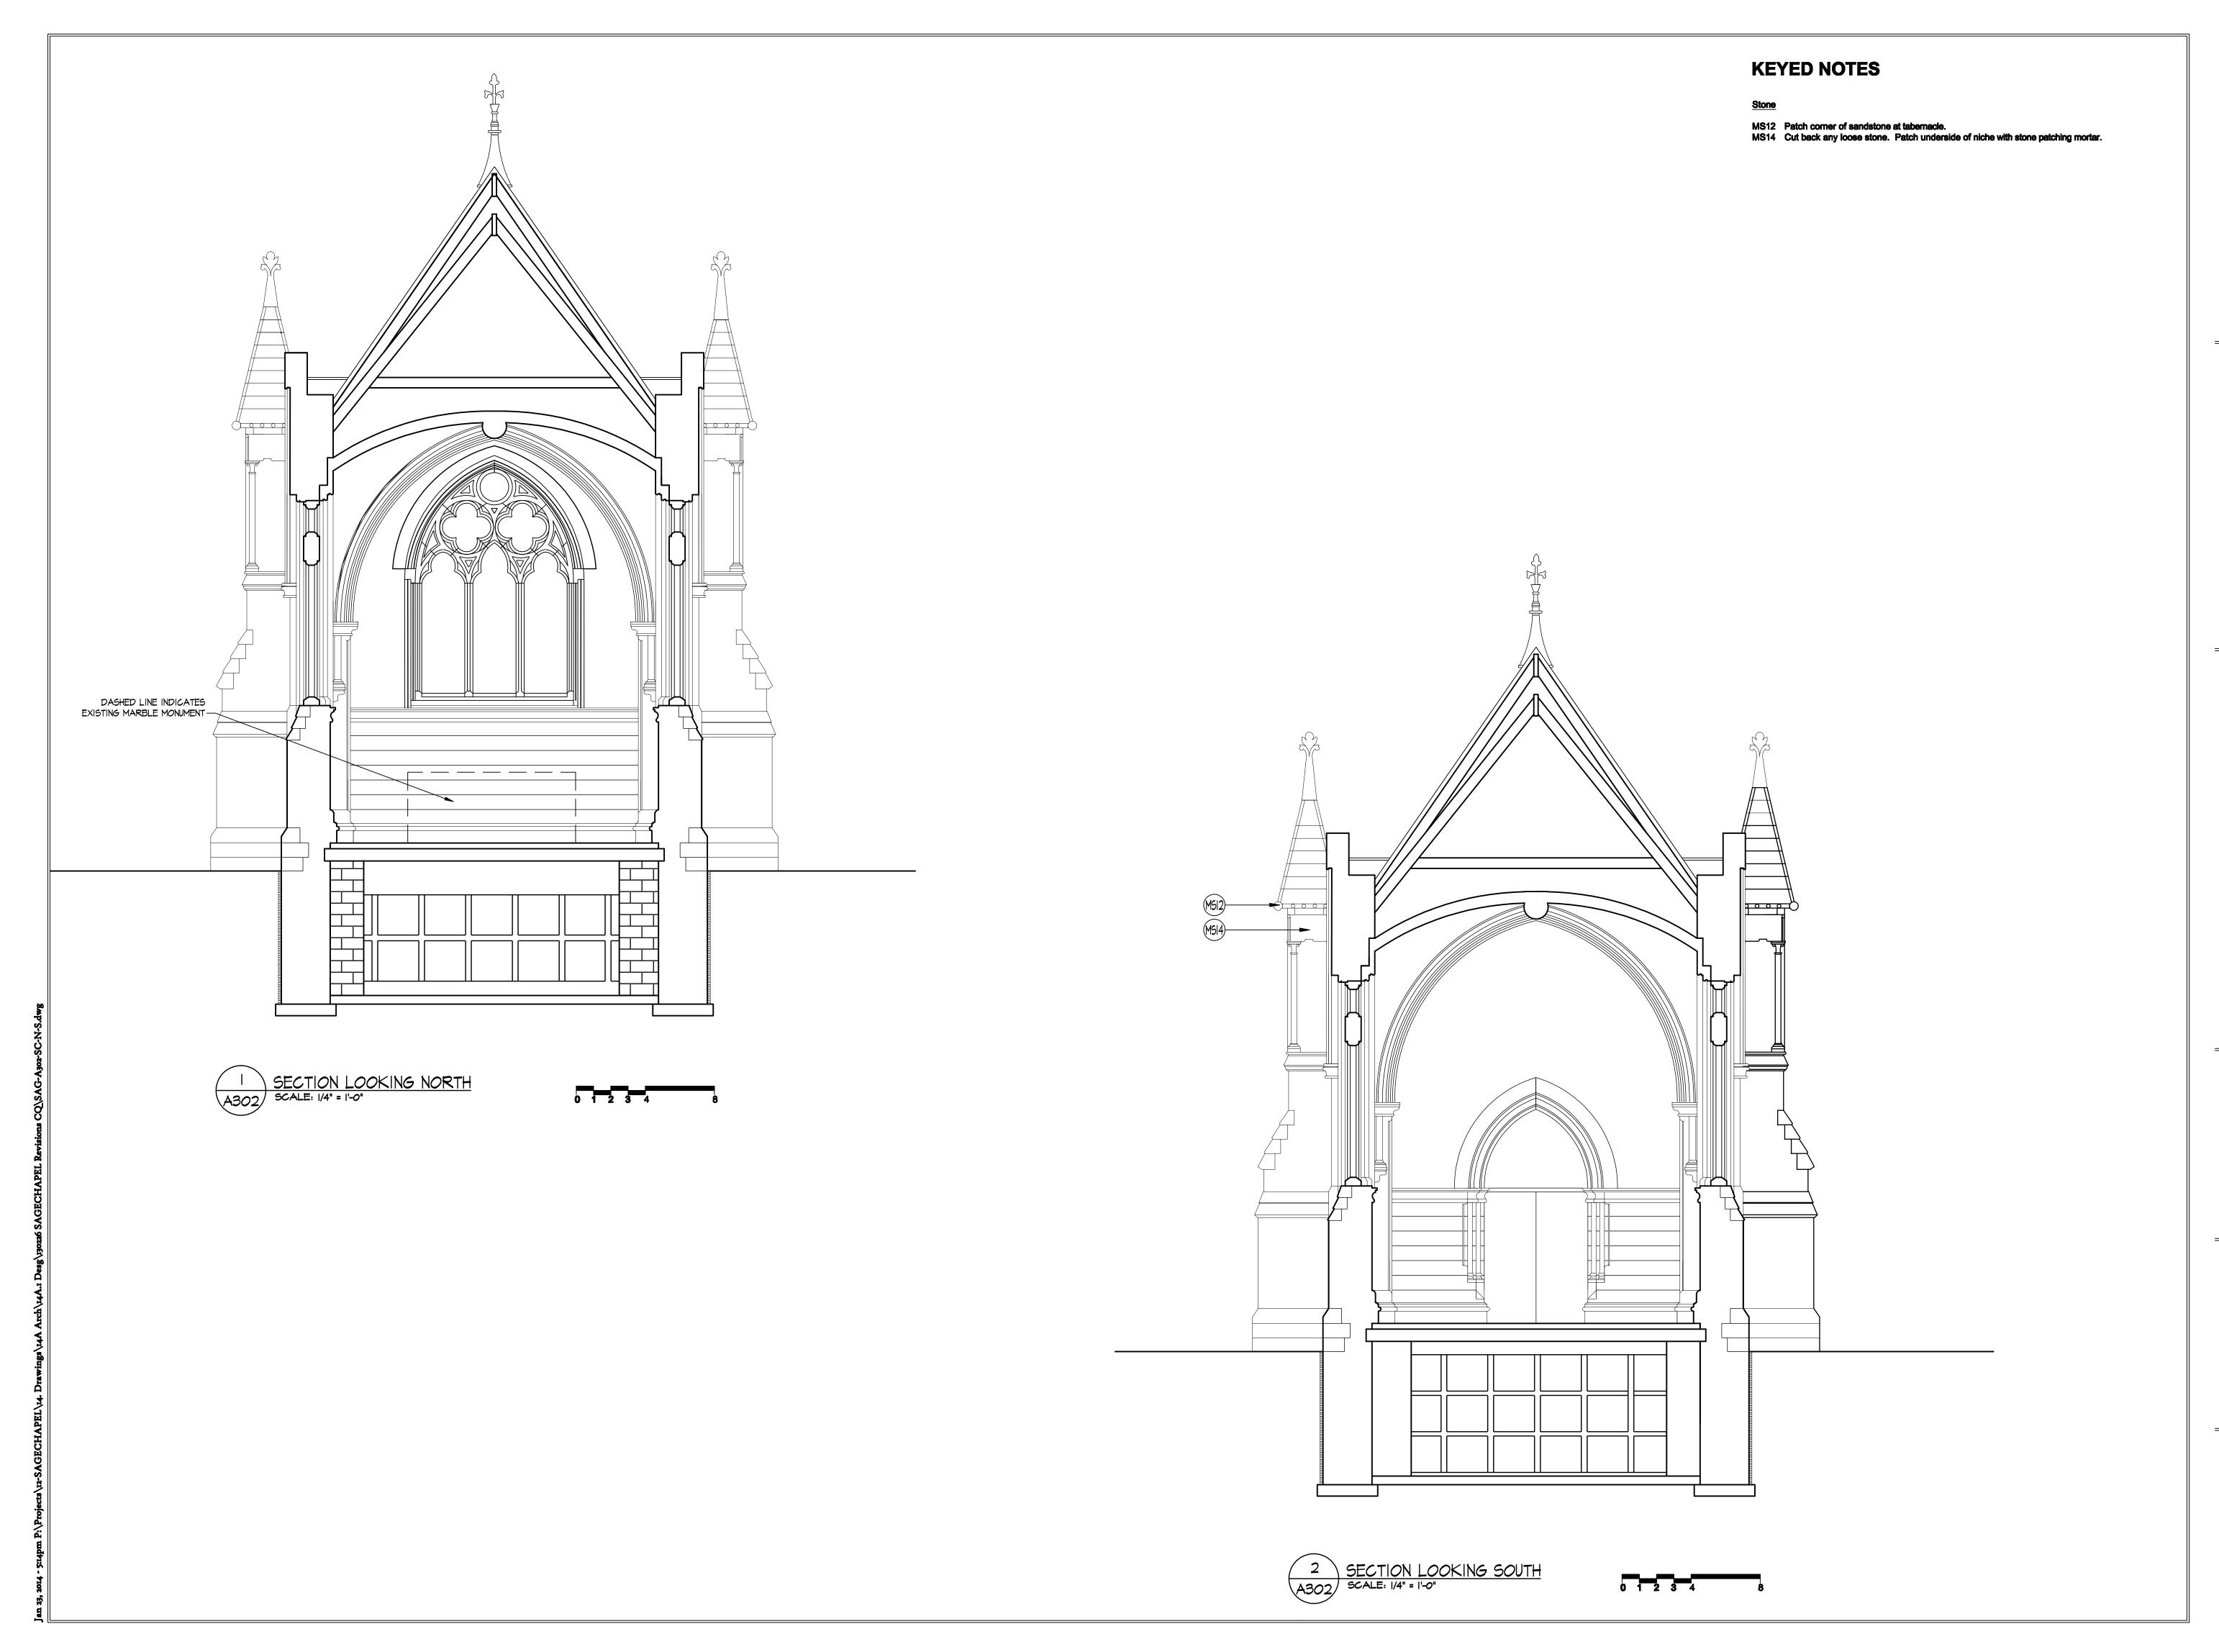Exterior Renovation of Memorial Chapel

for Cornell University Facilities Services Ithaca, New York



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Structural Engineer
Robert Silman Associates
Boston, MA

CONSTRUCTION DOCUMENTS





project: SAGECHAP!
drawn: JB. C
checked: J
phase: C:
date: 22 January 26
revised:

NORTH & SOUTH BUILDING SECTIONS

A302



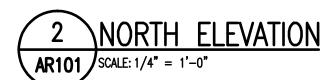

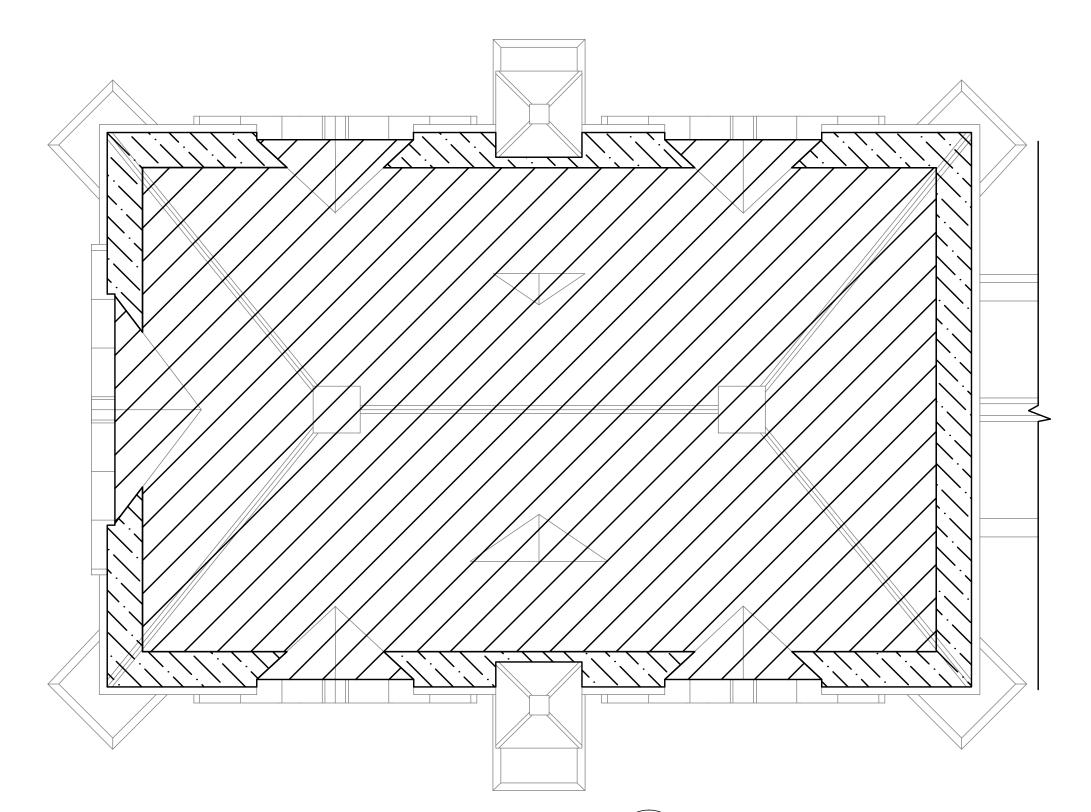

ASBESTOS ABATEMENT NOTES:

- THE NOTES AND DETAILS PRESENTED HERE AND IN SPECIFICATION SECTION 028213 ARE APPLICABLE TO DRAWING AR101. ASBESTOS ROOFING ABATEMENT OPERATIONS SHALL BE PERFORMED AT THE SAGE CHAPEL (BUILDING 2005) MEMORIAL CHAPEL WING ROOF LOCATED ON THE CORNELL UNIVERSITY CAMPUS IN ITHACA, NEW YORK.
- CONTRACTOR SHALL VERIFY ALL EXISTING CONDITIONS, DIMENSIONS AND QUANTITIES. ANY DISCREPANCIES SHALL BE BROUGHT TO THE ENGINEERS ATTENTION PRIOR TO BID.
- THE CONTRACTOR SHALL PERFORM ALL CONTRACT WORK IN ACCORDANCE WITH THE CONTRACT DOCUMENTS, DRAWINGS, AND SPECIFICATIONS. ASBESTOS ABATEMENT OPERATIONS SHALL BE PERFORMED AS PER THE PROVISIONS AND CONDITIONS LISTED IN THE NEW YORK STATE DEPARTMENT OF LABOR (NYS DOL) INDUSTRIAL CODE RULE NO. 56 (CITED AS 12 NYCRR PART 56) AND APPLICABLE OSHA, NESHAPS AND OTHER PERTINENT CODES.
- MEMORIAL CHAPEL ROOF ABATEMENT OPERATIONS SHALL INCLUDE THE REMOVAL OF THE FOLLOWING ASBESTOS CONTAINING/ASBESTOS CONTAMINATED MATERIALS:
 - A) APPROXIMATELY 1,700 SQUARE FEET OF SLATE SHINGLES AND UNDERLYING FRIABLE
 - ASBESTOS CONTAINING SHEET PAPER. B) APPROXIMATELY 186 SQUARE FEET OF SLATE SHINGLES AND UNDERLYING NON-FRIABLE ORGANICALLY BOUND (NOB) FELT PAPER. THIS NOB FELT PAPER IS PRESENT FROM THE ROOF EDGE BACK APPROXIMATELY 18" INTO THE MAIN ROOF FIELD ALONG ALL MAIN ROOF
- C) BLACK REPAIR TAR PRESENT ON ALL DORMER VALLEYS, RIDGE SEAMS, ROOF JOINTS AND APPLIED RANDOMLY AS A REPAIR MECHANISM ON THE SLATE SHINGLES.
- THE REMOVAL OF THE ASBESTOS CONTAINING/ASBESTOS CONTAMINATED ROOFING MATERIALS SHALL BE PERFORMED AS PER THE PROVISIONS AND CONDITIONS OF THE PROJECT SPECIFIC VARIANCE ISSUED FOR THIS PROJECT (SEE ATTACHMENT A OF ASBESTOS ABATEMENT SPECIFICATION SECTION 028213) AND ALL OTHER APPLICABLE SECTIONS OF 12 NYCRR PART 56.
- FOR SLATE SHINGLE AND UNDERLYING FRIABLE ASBESTOS CONTAINING SHEET PAPER ABATEMENT OPERATIONS, REMOVAL SHALL BE LIMITED TO A 25 SF SECTION OF SLATE/PAPER AT ANY GIVEN TIME IN ORDER TO MINIMIZE THE POTENTIAL EXPOSURE AND IMPACT TO THE FRIABLE SHEET. UPON REMOVAL OF A GIVEN 25 SF SECTION OF SLATE/PAPER, CONTAINERIZING OF THE GENERATED RACM AND FINAL CLEANING OF THE ROOF DECK, REMOVAL OF THE NEXT 25 SF SECTION SHALL BE PERFORMED.
- ALL FRIABLE WASTE (I.E. MAIN FIELD FRIABLE ACM PAPER SHEET AND ASSOCIATED CONTAMINATED SLATE SHINGLES) SHALL BE PLACED IN TWO LABELED 6-MIL POLY DISPOSAL BAGS, TRANSPORTED. AND DISPOSED OF AS A REGULATED ASBESTOS CONTAINING MATERIAL (RACM) IN ACCORDANCE WITH ALL FEDERAL, STATE AND LOCAL REGULATIONS. ALL DUMPSTERS USED FOR RACM WASTE SHALL BE COMPLETELY ENCLOSED AND SECURABLE.
- ALL NOB ACM WASTE (I.E. REPAIR TAR, NOB PERIMETER/EDGE FELT PAPER AND ASSOCIATED CONTAMINATED SLATE SHINGLES) SHALL BE PROPERLY PACKAGED, TRANSPORTED AND DISPOSED OF AS ACM NOB C&D IN ACCORDANCE WITH ALL FEDERAL, STATE AND LOCAL REGULATIONS.
- SLATE SHINGLES FREE OF FRIABLE ACM AND NOB ACM RESIDUE/CONTAMINATION CAN BE DISPOSED OF AS GENERAL C&D WASTE.
- 10. THE ABATEMENT CONTRACTOR SHALL COORDINATE THE SCHEDULED WORK WITH THE OWNER'S REPRESENTATIVE AND ALL OTHER TRADES.
- 11. THE ABATEMENT CONTRACTOR SHALL MAINTAIN SECURITY IN EACH WORK AREA AT ALL TIMES.
- 12. THE LOCATION OF REMOTE DECONTAMINATION UNITS AND WASTE DUMPSTERS/TRAILERS MUST BE APPROVED BY THE OWNERS REPRESENTATIVE PRIOR TO THE START OF THE PROJECT.
- 13. THE CONTRACTOR SHALL SUBMIT A WRITTEN WORK PLAN FOR ASBESTOS ABATEMENT OPERATIONS FOR REVIEW AND APPROVAL AS PER THE REQUIREMENTS OF SPECIFICATIONS SECTION 028213,
- 14. ALL EQUIPMENT ON THE ROOF WORK AREA, ONE FLOOR BELOW THE ROOF AND WITHIN 25' OF THE ACTIVE REGULATED ABATEMENT AREA, INCLUDING BUT NOT LIMITED TO OPERABLE WINDOWS, AIR INTAKES, VENTS, VENTILATORS AND ANY OTHER OPENINGS INTO THE BUILDING SHALL BE COVERED AND SEALED WITH TWO (2) LAYERS OF 6-MIL FIRE RETARDANT POLYETHYLENE SHEET. SHOULD THE WORK INTERFERE WITH VENTING PLUMBING STACKS, FACILITY USERS <u>MUST</u> BE CONTACTED PRIOR TO COVERING OR SEALING.
- 15. ALL PROJECT MONITORING REQUIRED TO SATISFY THE REQUIREMENTS OF 12 NYCRR PART 56 AND THE PROJECT SPECIFIC VARIANCE SHALL BE PERFORMED BY A THIRD PARTY INDEPENDENT ENVIRONMENTAL CONSULTANT HIRED DIRECTLY BY THE OWNER. THE CONTRACTOR SHALL COORDINATE WITH THE THIRD PARTY CONSULTING FIRMS ONSITE ASBESTOS PROJECT MONITOR (APM). AIR MONITORING TO SATISFY OSHA REQUIREMENTS SHALL BE THE CONTRACTORS
- 16. CONTRACTOR SHALL RECEIVE APPROVAL FOR EACH WORK AREA BASED ON THE APM'S INSPECTION TO ASSURE ALL OPENINGS AND PENETRATIONS HAVE BEEN SEALED PROPERLY AND ALL WORK AREA PREPARATION IS COMPLETE BEFORE ANY ABATEMENT IS UNDERTAKEN.
- 17. COORDINATE ALL ASBESTOS ABATEMENT (INCLUDING BUT NOT LIMITED TO CONTAINMENT CONFIGURATIONS, DECONTAMINATION UNIT LOCATIONS AND SEQUENCE OF ABATEMENT) WITH THE OWNER'S REPRESENTATIVE.
- 18. COORDINATE HOOK-UP OF WATER SOURCE/SERVICE FOR ABATEMENT WORK AND DECONTAMINATION PURPOSES WITH THE OWNER. TEMPORARY WATER CONNECTIONS SHALL BE MADE BY THE CONTRACTOR AND MAINTAINED IN A LEAK FREE STATE AT ALL TIMES.
- 19. UNDER NO CIRCUMSTANCES SHALL CONTAMINATED LIQUIDS OR DEBRIS ENTER THE EXISTING SEWER SYSTEM. ALL WASTEWATER SHALL BE FILTERED THROUGH A SYSTEM WITH AT LEAST 5.0 MICRON PARTICLE SIZE COLLECTION CAPABILITY. THE CONTRACTOR SHALL BE RESPONSIBLE FOR ANY WASTE WATER PERMITS REQUIRED TO PERFORM HIS WORK UNDER THIS CONTRACT. ANY COST ASSOCIATED WITH WASTE WATER PERMITS SHALL BE INCLUDED IN HIS BID.
- 20. CONTINUAL WATER-TIGHTNESS OF THE ROOF IS THE RESPONSIBILITY OF THE CONTRACTOR. IF AN ASBESTOS SUB-CONTRACTOR IS USED, HE SHALL COORDINATE WITH THE ROOFING CONTRACTOR REGARDING ANY TEMPORARY ROOFING REQUIREMENTS TO ASSURE THAT THE ROOF IS WATER-TIGHT AT ALL TIMES.
- 21. THE AMOUNT OF ASBESTOS ROOFING MATERIAL REMOVED IN A GIVEN DAY SHALL NOT EXCEED THE AMOUNT OF TEMPORARY AND/OR PERMANENT ROOFING THAT CAN BE REPLACED BY THE END OF THE GIVEN DAY.
- 22. REFERENCE DRAWINGS A201 AND A202 FOR ADDITIONAL ELEVATION VIEWS AND DETAILS.

Cornell University

Facilities Services 200 Humphreys Service Building

Ithaca, NY 14853

No. Revision

EXTERIOR RENOVATIONS MEMORIAL CHAPEL AT SAGE CHAPEL

Date

ITHACA



Endwell, New York 13760 Tel: 607.231.6600 Fax: 607.231.6651 Email: mail@deltaengineers.com



AS SHOWN 2014.044.348 WARNING: THE ALTERATION OF THIS MATERIAL IN ANY WAY, UNLESS DONE UNDER THE DIRECTION OF A COMPARABLE PROFESSIONAL, I.E. ARCHITECT FOR AN ARCHITECT, ENGINEER FOR AN ENGINEER, LANDSCAPE ARCHITECT FOR A LANDSCAPE ARCHITECT FOR A LANDSCAPE ARCHITECT OR LICENSED SURVEYOR FOR A LICENSED SURVEYOR, IS A VOLATION OF THE NEW (ORK STATE EDUCATION LAW AND/OR REGULATIONS AND IS A CLASS 'A' MISDEMEANOR.

JANUARY 22, 2014

Drawing Title

ASBESTOS ABATEMENT PLAN

Drawing No.



SLATE SHINGLES AND UNDERLYING FRIABLE ASBESTOS CONTAINING PAPER SHEET TO BE REMOVED - 1,700 SF.

SLATE SHINGLES AND UNDERLYING NON-FRIABLE ORGANICALLY BOUND (NOB) ASBESTOS CONTAINING FELT PAPER (PRESENT FROM ROOF EDGE-BACK 18") TO BE REMOVED — 186 SF.

ASBESTOS CONTAINING NOB BLACK REPAIR TAR TO BE REMOVED IS NOT SHOWN BUT IS PRESENT ON DORMER VALLEYS, VARIOUS ROOF JOINTS AND RANDOMLY ON SLATE SHINGLES AS A REPAIR MECHANISM.

GRAPHIC SCALE: 1/4" = 1'-0"

BUILDING-STRUCTURE INVENTORY FORM

DIVISION FOR HISTORIC PRESERVATION NEW YORK STATE PARKS AND RECREATION ALBANY, NEW YORK (\$18) 474-0479


FOR OFFIC	E USE ONLY
UNIQUE SI	TE NO.
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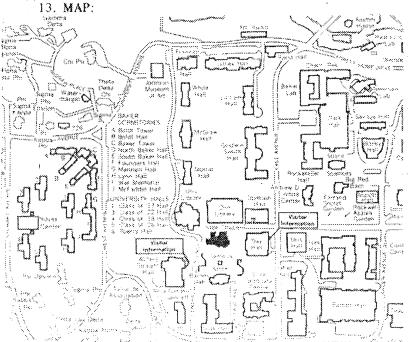
YOUR NAME: Mary Donohue * DATE: 9/20/78	
YOUR ADDRESS: 111 Cascadilla Avenue TELEPHONE: 277-0486	
ORGANIZATION (if any): Cornell University	
* * * * * * * * * * * * * * * * * * *	
I BUILDING NAME(S): Sage Chapel 2 COUNTY: Tompkins TOWN/CITY: Ithaca VILLAGE:	
2. COUNTY: Tompkins TOWN/CITY: Ithaca VILLAGE:	
3. STREET LOCATION: East side of Central Avenue, south of Arts Quad	
4. OWNERSHIP: a public D b private 🗓	
S. PRESENT OWNER Cornell University ADDRESSIthaca, NY	
6. USB: Original: Chapel Present: Chapel Chapel 7. ACCESSIBILITY TO PUBLIC: Exterior visible from public road: Yes X No Univers	i ji di
Wereparative to loging extensivisms thought to a see the control of the control o	sity road
Interior accessible: Explain Sunday Services ————————————————————————————————————	•
8. BUILDING a. clapboard □ b. stone 収 c. brick 文 d. board and batten □ MATERIAL e. cobblestone □ f. shingles 収 g. stucco □ other:	
slate	
9. STRUCTURAL ac wood frame with interlocking joints []	
SYSTEM: b. wood frame with light members	
(if known) c. masonry load bearing walls 🔀 d. metal (explain)	
e. other	
0. CONDITION: a excellent 🔀 b. good 🗆 c. fair 🗖 d. deteriorated 🗀	
1: INTEGRITY: a original site 📝 b. moved 🗔 if so, when?	
c. list major alterations and dates (if known):	
ethologisk er til godern for for er et og for en et filliger til ført og en en en stelle et et en en en en en Det en en skæret for en en	

1883 Memorial Antechapel added to north side of main chapel

1898 "In 1898 the seating capacity was doubled. The south transept, the tower (con't)

12.1184OTO:



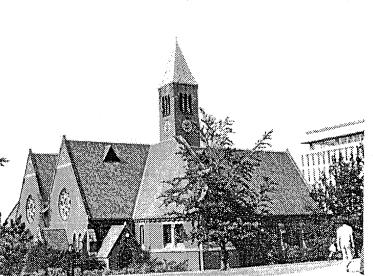

14. THREATS TO BUILDING: a. none known b. zoning c. roads c. roads d. developers e. deferioration c
f. other: 15. RELATED OUTBUILDINGS AND PROPERTY: a. barn b. carriage house c. garage d. privy e. shed f. greenhouse g. shop h. gardens i. landscape features: j. other: Venetian wellhead between Memorial Chapel and
j. other: Veriettall Wellhead Serween Month Transcept a. open land b. woodland c. scattered buildings d. densely built-up e. commercial f. industrial g. residential h. other:
17. INTERRELATIONSHIP OF BUILDING AND SURROUNDINGS: (Indicate if building or structure is in an historic district)
Sage Chapel is located south of the stone Arts Quad and is part of an informal grouping of brick buildings which include Barmes Hall and Sage College. These 3 brick structures are of a similiar age and reflect the Venetian Gothic influences of the late nineteenth century. 18. OTHER NOTABLE FEATURES OF BUILDING AND SITE (including interior features if known): The Memorial Antechapel of 1883 "is of the 'Middle French Pointed School!The vaulting ribs of Ohio stone are supported on red marble columns; the ceiling panels are Caen stone. Beneath the north window is a recumbent heroic size' figure of Ezra Cornell, which was carved in white marble by an American Expatriate in Rome, William Story. Elsewhere in the room are similar reclining statues including those of Mary White, White's first wife, and Jennie NcGraw Fiske. The room, rich in (con't SIGNIFICANCE Begun 1872, Completed 1875
ARCHITECT:Charles Babcock, Cornell University, Ithaca, NY
Builder-John Snaith Stonecarver-Robert Richardson
The building is named after Mr. and Mrs. Henry Sage. Sage served as a Cornell trustee and donated the funds to construct both Sage Chapel and Sage College for Women. The total cost of the initial building was \$24,775. The Chapel is used to present speakers of different faiths to the student body. Cornell University was founded as a unsectarian facility and the University Charter states"at no time shall the majority of the board be of one religious or of no religious sect", but it was felt that the student body should have

access to religious leaders.

The architect, Charles Babcock, was Cornell's first professor of architecture and an Episcopalian minister.

21. SOURCES:

THE CORNELL CAMPUS, K.C. Parsons, Cornell University Press, Ithaca, NY, 1968. Cornell University Archives, Babcock Drawings, Microfilm

22. THEME:

14. THREATS TO BUILDING: a. none known b. zoning c. roads d. developers e. deferioration f. other:	
15. RELATED OUTBUILDINGS AND PROPERTY: a. barn b. carriage house c. garage d. privy e. shed f. greenhouse g. shop h. gardens i. landscape features: j. other: Venetian wellhead between Memorial Chapel and	
16. SURROUNDINGS OF THE BUILDING (check more than one if necessary): North Transcept a. open land b. woodland c. c. scattered buildings d. d. densely built-up e. commercial f. industrial g. residential h. other:	
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Charles Babcock, Cornell University, Ithaca, Ni	
Builder-John Snaith Stonecarver-Robert Richardson BUILDER:	
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THE CORNELL CAMPUS, K.C. Parsons, Cornell University Press, Ithaca, NY, 1968. Cornell University Archives, Babcock Drawings, Microfilm

22. THEME:

SAGE CHAPEL, CORNELL UNIVERSITY, ITHACA, TOMPKINS COUNTY, NEW YORK

11. INTEGRITY:

and the east half of the original nave were demolished and two great parallel north-south transepts covering a space sixty-six by sixty-four feet were added. Rose windows with stained glass of the Byzantine School' were placed in the four new gables. The nave was lengthened, new porches were built, and the Sage Memorial Apse was added at the east end..." (Parsons, p. 86-87)

1903 North wall of the northeast transept removed and moved northward; ceiling paintings added

1940 Nave extended forty feet, retained original rose window

18. OTHER NOTABLE FEATURES OF BUILDING AND SITE

memorials to founders, trustees, benefactors, presidents, and professors of the nineteenth century, has of late been called 'Coznell's pantheon'." (Parsons, p.85)

"The apse is semi-octagonal, thirty-one feet wide and sixteen feet deep.

On its mosaic walls below the window sills, a procession, forty-two by seven

feet, of life-size figures symbolizes the work of the University. A young man and

a young woman representing coeducation stand at each end and are seperated by eight

figures representing the sciences and the arts...This allegorical mosaic was designed

and supervised by Charles R. Lamb of New York and executed by J. and R. Lamb."

(Parsons, p. 87)

The exterior is of High Victorian Gothic design and features coloristic effects such as banding in the brickwork, contrasting materials such as stone, brick, and slate, and fine craftsmanship. It follows the tenets described by the theorists Pugin and Ruskin in its use of the Gothic mode of design.