

330 East State Street, Ithaca, New York 14850 tel 607-277-0845 fax 607-277-2925 www.schickel.com

March 20, 2013

Ms. Lisa Nicholas, Senior Planner City of Ithaca Department of Planning & Economic Development 108 East Green Street Ithaca, NY 14850

Re: Maguire Fiat: 308 Elmira Road

SA Project No. 12115

Dear Ms. Nicholas:

For the proposed Maguire Fiat dealership located at 308 Elmira Road a complete set of documents are resubmitted as follows (15 sets of 11x17 drawings with cover letter, 1 full size set of black and white drawings only on 24x36):

•	Title Sheet	Revision 1	Mar. 20, 2013
•	Drawing C1 - Layout Plan (color rendering)	Revision 4	Mar. 5, 2013
•	Drawing C2 – Elevations (color rendering)	Revision 1	Jan. 18, 2013
•	Topographic Map	Revision 1	Jul. 2, 2012
•	Drawing C1 - Layout Plan	Revision 5	Mar. 20, 2013
•	Drawing C2 - Planting Plan	Revision 3	Mar. 20, 2013
•	Drawing C3 - Pavement Plan	Revision 1	Mar. 20, 2013
•	Drawing C4 - Grading Plan	Revision 1	Mar. 20, 2013
•	Drawing C5 - Utility Plan	Revision 1	Mar. 20, 2013
•	Drawing C6 – Site Details	Revision 1	Mar. 20, 2013
•	Drawing A1 – Floor Plan		Jan. 4, 2012
•	Drawing A2 – Elevations	Revision 2	Feb. 8, 2013

All drawings above dated prior to March 20, 2013 were submitted previously and are included here unchanged from prior submissions. All drawings above dated March 20, 2013 are resubmitted with revisions from prior submissions.

A summary of revisions from the presentation to the Planning Board on February 26^{th} is as follows:

- 1. A bike rack with a capacity for 2 bikes has been added on the south side of the building.
- 2. Lawn mounds have been added at the front of the 4 parking spaces along Elmira Road and the 7 parking spaces along the east side of the site as an equivalent to curbs or wheel stops.

MAGUIRE FIAT

Maguire Family Enterprises, LLC

308 ELMIRA ROAD ITHACA, NEW YORK 14850

PROJECT NO. 12115 SEPTEMBER 21, 2012 **REVISION NO. 1 - MARCH 20, 2013**



Schickel Architecture

330 EAST STATE STREET ITHACA, NEW YORK 14850 TEL 607.277.0845 FAX 607.277.2925

ARCHITECTURAL ABBREVIATIONS ACOUSTICAL CEILING TILE MECHANICAL CONTRACTOR MECH MECHANICAL ADDENDUM ABOVE FINISH FLOOR ALTERNATE MISC MISCELLANEOUS BUILDING BLOCKING NOT APPLICABLE BOTTOM OF FOOTING NOT IN CONTRACT BOTTOM NOISE REDUCTION COEFFICIENT NET SQUARE FEET CENTER LINE, CLOSET CEILING CLL CLR CONTRACT LIMIT LINE OUTSIDE DIAMETER CONCRETE MASONRY UNIT OVERHEAD CONCRETE CONSTRUCTION PLUMBING CONTRACTOR PRECAST CONCRETE PLATE, PROPERTY LINE DEMOLISH. DEMOLITION DIA DIAMETER PLASTIC LAMINATE PLYWD PLYWOOD DIM DIMENSION PREPARE, PREPARED PREP DIVISION DEAD LOAD POUNDS PER SQUARE FOOT POUNDS PER SQUARE INCH DOWN DITTO POINT, PRESSURE TREATED DOOR DTL PTM PATCH TO MATCH DETAIL DRAWING PVC POLYVINYL CHLORIDE RISER, RADIUS EACH RCP REFLECTED CEILING PLAN ELECTRICAL CONTRACTOR ROOF DRAIN REF FACH FACE REFERENCE REINFORCE, REINFORCED, REINFORCING EXTERIOR INSULATION FINISH SYSTEM REQD REQUIRED EXPANSION JOINT ELEC ELECTRIC, ELECTRICAL REV REVISION RIGHT HAND ETHYLENE PROPYLENE DIENE MONOMER EPDM RM ROOM ROUGH OPENING ETR EXISTING TO REMAIN EW EACH WAY SOLID CORE EXIST **EXISTING** SCHEDULE FXPANSION SQUARE FOOT EXTERIOR SIMILAR SLAB ON GRADE SPEC SPECIFICATION FLOOR DRAIN FDN FOUNDATION STAINLESS STEEL FINISH FLOOR STANDARD FIBERGLASS FIN STOR FINISH STORAGE STR STRUCTURAL FLOOR FOW FACE OF WALL SUSPENDED FR FT FRAME SQUARE YARD FEET SYM SYMMETRICAL TREAD TOP AND BOTTOM GA GAUGE GALV GALVANIZED TONGUE AND GROOVE GENERAL CONTRACTOR TEMPERATURE GLASS THICK, THICKNESS GRADE THRESHOLD GSF TOM TOP OF MASONRY GROSS SQUARE FEET TOP GYP GYPSUM TOP OF PIER TOP OF STEEL TOW TYP TOP OF WALL HOLLOW CORE HARD, HAND TYPICAL HDW HARDWARE UNDERCUT НМ HOLLOW METAL HORZ HORIZONTAL UNDERGROUND HANDRAIL, HOUR UNLESS NOTED OTHERWISE HFIGHT HEATING, VENTILATING & AIR CONDITIONING VINYL ASBESTOS TILE VINYI BASE INSIDE DIAMETER VINYL COMPOSITION TILE VERT INSUL INSULATION VERIFY IN FIELD INTERIOR WOOD JANITOR'S CLOSET WAINSCOT WELDED WIRE FABRIC POUND WITH LBL

WITHOUT

YARD


LABEL

LIVE LOAD

LH LEFT HAND

LGSMF LIGHT GAUGE STRUCTURAL METAL FRAMING

ARCHITECTURAL SYMBOLS

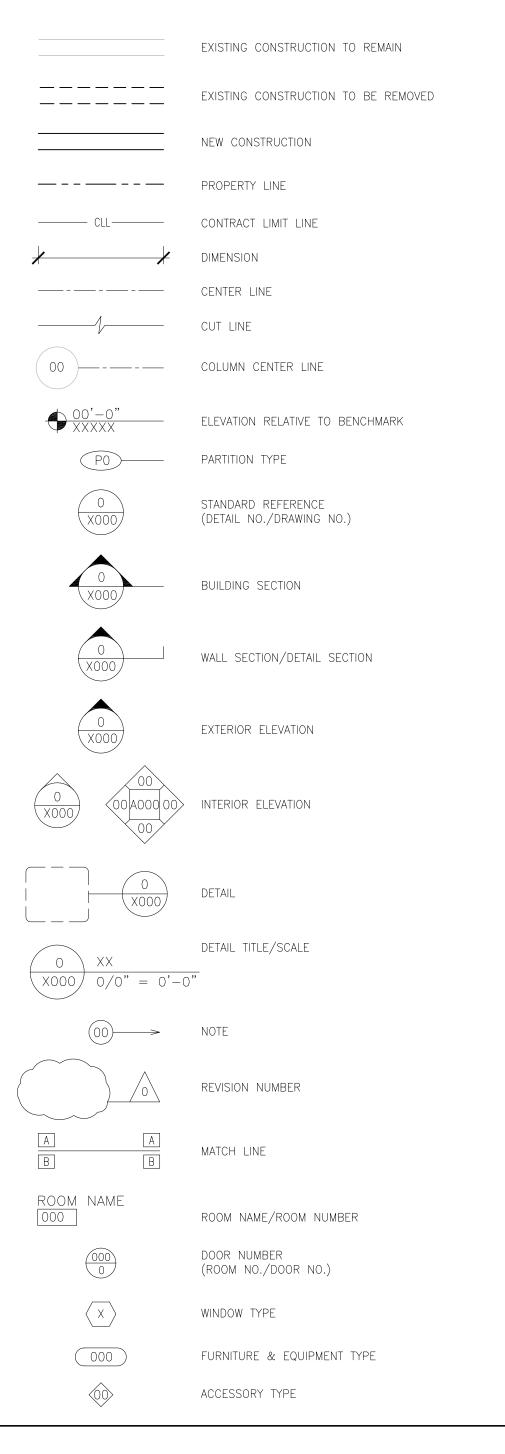

LIST OF DRAWINGS

	TITLE SHEET		
COLORE	ED RENDERINGS		
C1 A2	LAYOUT PLAN ELEVATIONS	REVISION NO. 4 REVISION NO. 1	MARCH 5, 2013 JANUARY 18, 2013
SITE			
1 C1 C2 C3 C4 C5 C6	TOPOGRAPHIC MAP LAYOUT PLAN PLANTING PLAN PAVEMENT PLAN GRADING PLAN UTILITY PLAN SITE DETAILS	REVISION NO. 1 REVISION NO. 5 REVISION NO. 3 REVISION NO. 1 REVISION NO. 1 REVISION NO. 1 REVISION NO. 1	JULY 2, 2012 MARCH 20, 2013 MARCH 20, 2013 MARCH 20, 2013 MARCH 20, 2013 MARCH 20, 2013 MARCH 20, 2013
ARCHIT	ECTURAL		
A1 A2	FLOOR PLAN ELEVATIONS	REVISION NO. 2	JANUARY 4, 2013 FEBRUARY 8, 2013

CONSULTANTS

CIVIL CONSULTANT

Napierala Consulting

110 FAYETTE STREET MANLIUS, NEW YORK 13104 TEL 315.682.5580 FAX 315.682.5544

PROJECT INFORMATION PER BUILDING CODE OF NEW YORK STATE

PROPOSED

AUTOMATIC SPRINKLER

GROUP B / S-1 OCCUPANCY CLASSIFICATION **CONSTRUCTION TYPE** 1 (PARTIAL 2ND FLOOR) NUMBER OF STORIES 8,165 SF GROSS AREA (FOOTPRINT) GROSS AREA (FIRST AND SECOND FLOOR) 10,210 SF


BUILDING AREA CALCULATION

FOR REFERENCE ONLY. REFER TO PLANS FOR EXACT DIMENSIONS


NONE

	EXISTING TO BE DEMOLISHED	NEW BUILDING
FIRST FLOOR SF	1,300	8,165
SECOND FLOOR SF	1,200	2,045
BUILDING GROSS SF	2,500	10,210



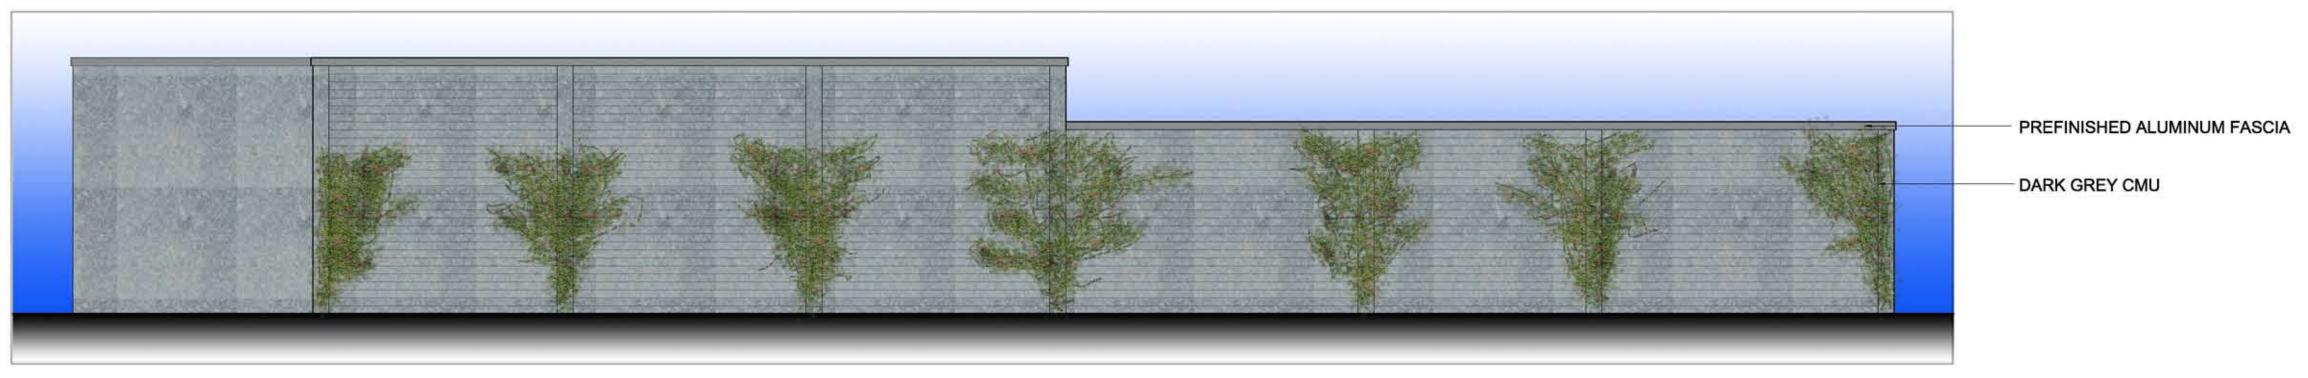


NORTH ELEVATION

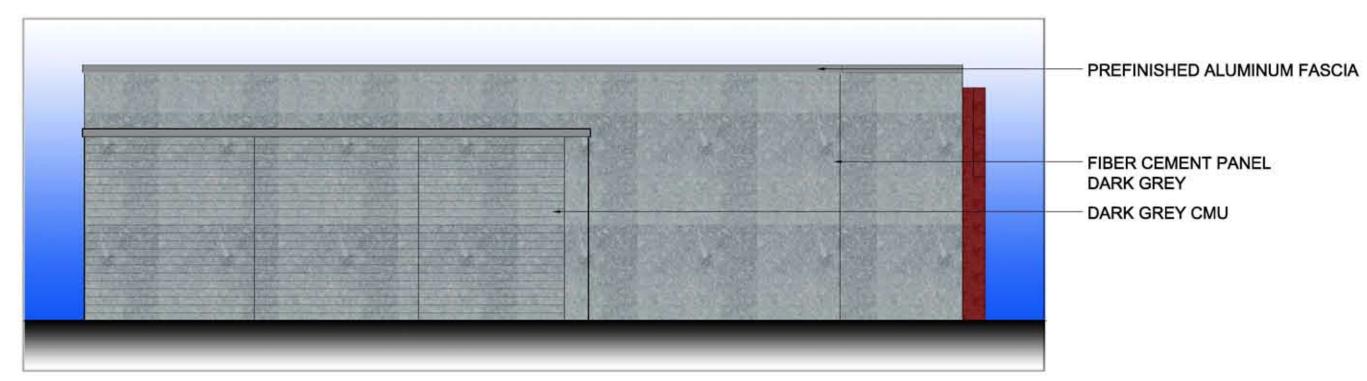

PREFINISHED ALUMINUM FASCIA Maguire FIBER CEMENT PANEL DARK GREY - ALUMINUM COMPOSITE METAL PANEL - Bbr RED DARK GREY CMU


 $\begin{array}{c}
3 \\
\hline
 A2
\end{array}$ EAST ELEVATION 1/8" = 1'-0"



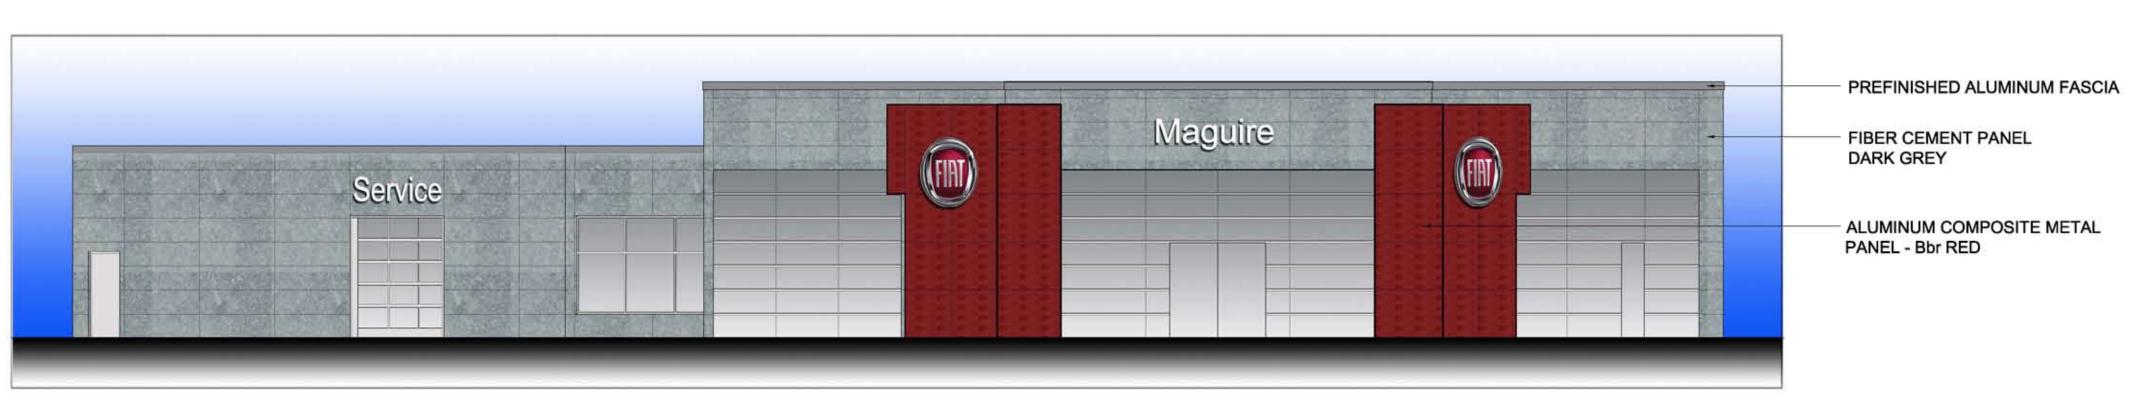

SOUTHEAST ELEVATION

A2 1/8" = 1'-0"

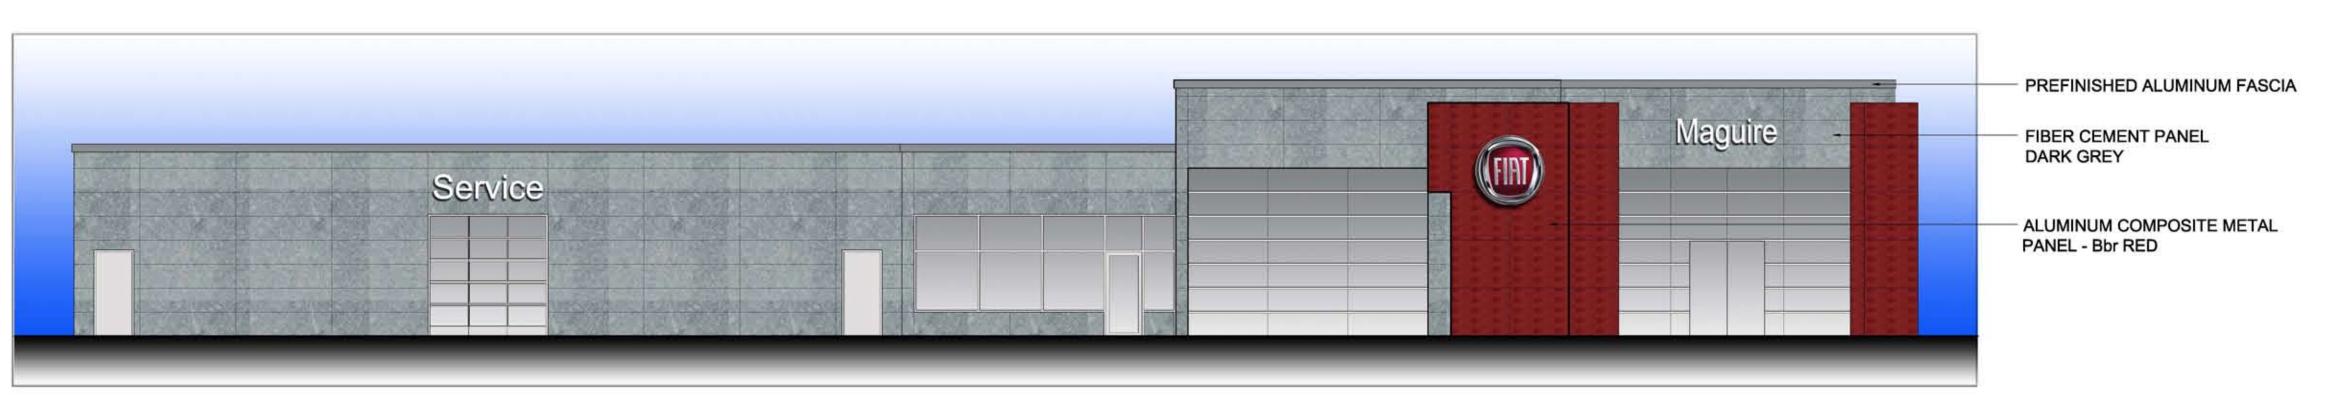

SOUTH ELEVATION

330 East State Street Ithaca, New York 14850 Tel 607.277.0845 Fax 607.277.2925

SEAL

CONSULTANT

CONSULTANT'S PROJECT NO.

MAGUIRE

PROJECT NO.

12115

OWNER

Maguire Family Enterprises, LLC 504 South Meadow Street Ithaca, NY 14850


REV	DATE	ISSUED FOR
	01-04-2013	BZA Submission
1	01-18-2013	BZA Submission
2		
3		
4		
5		


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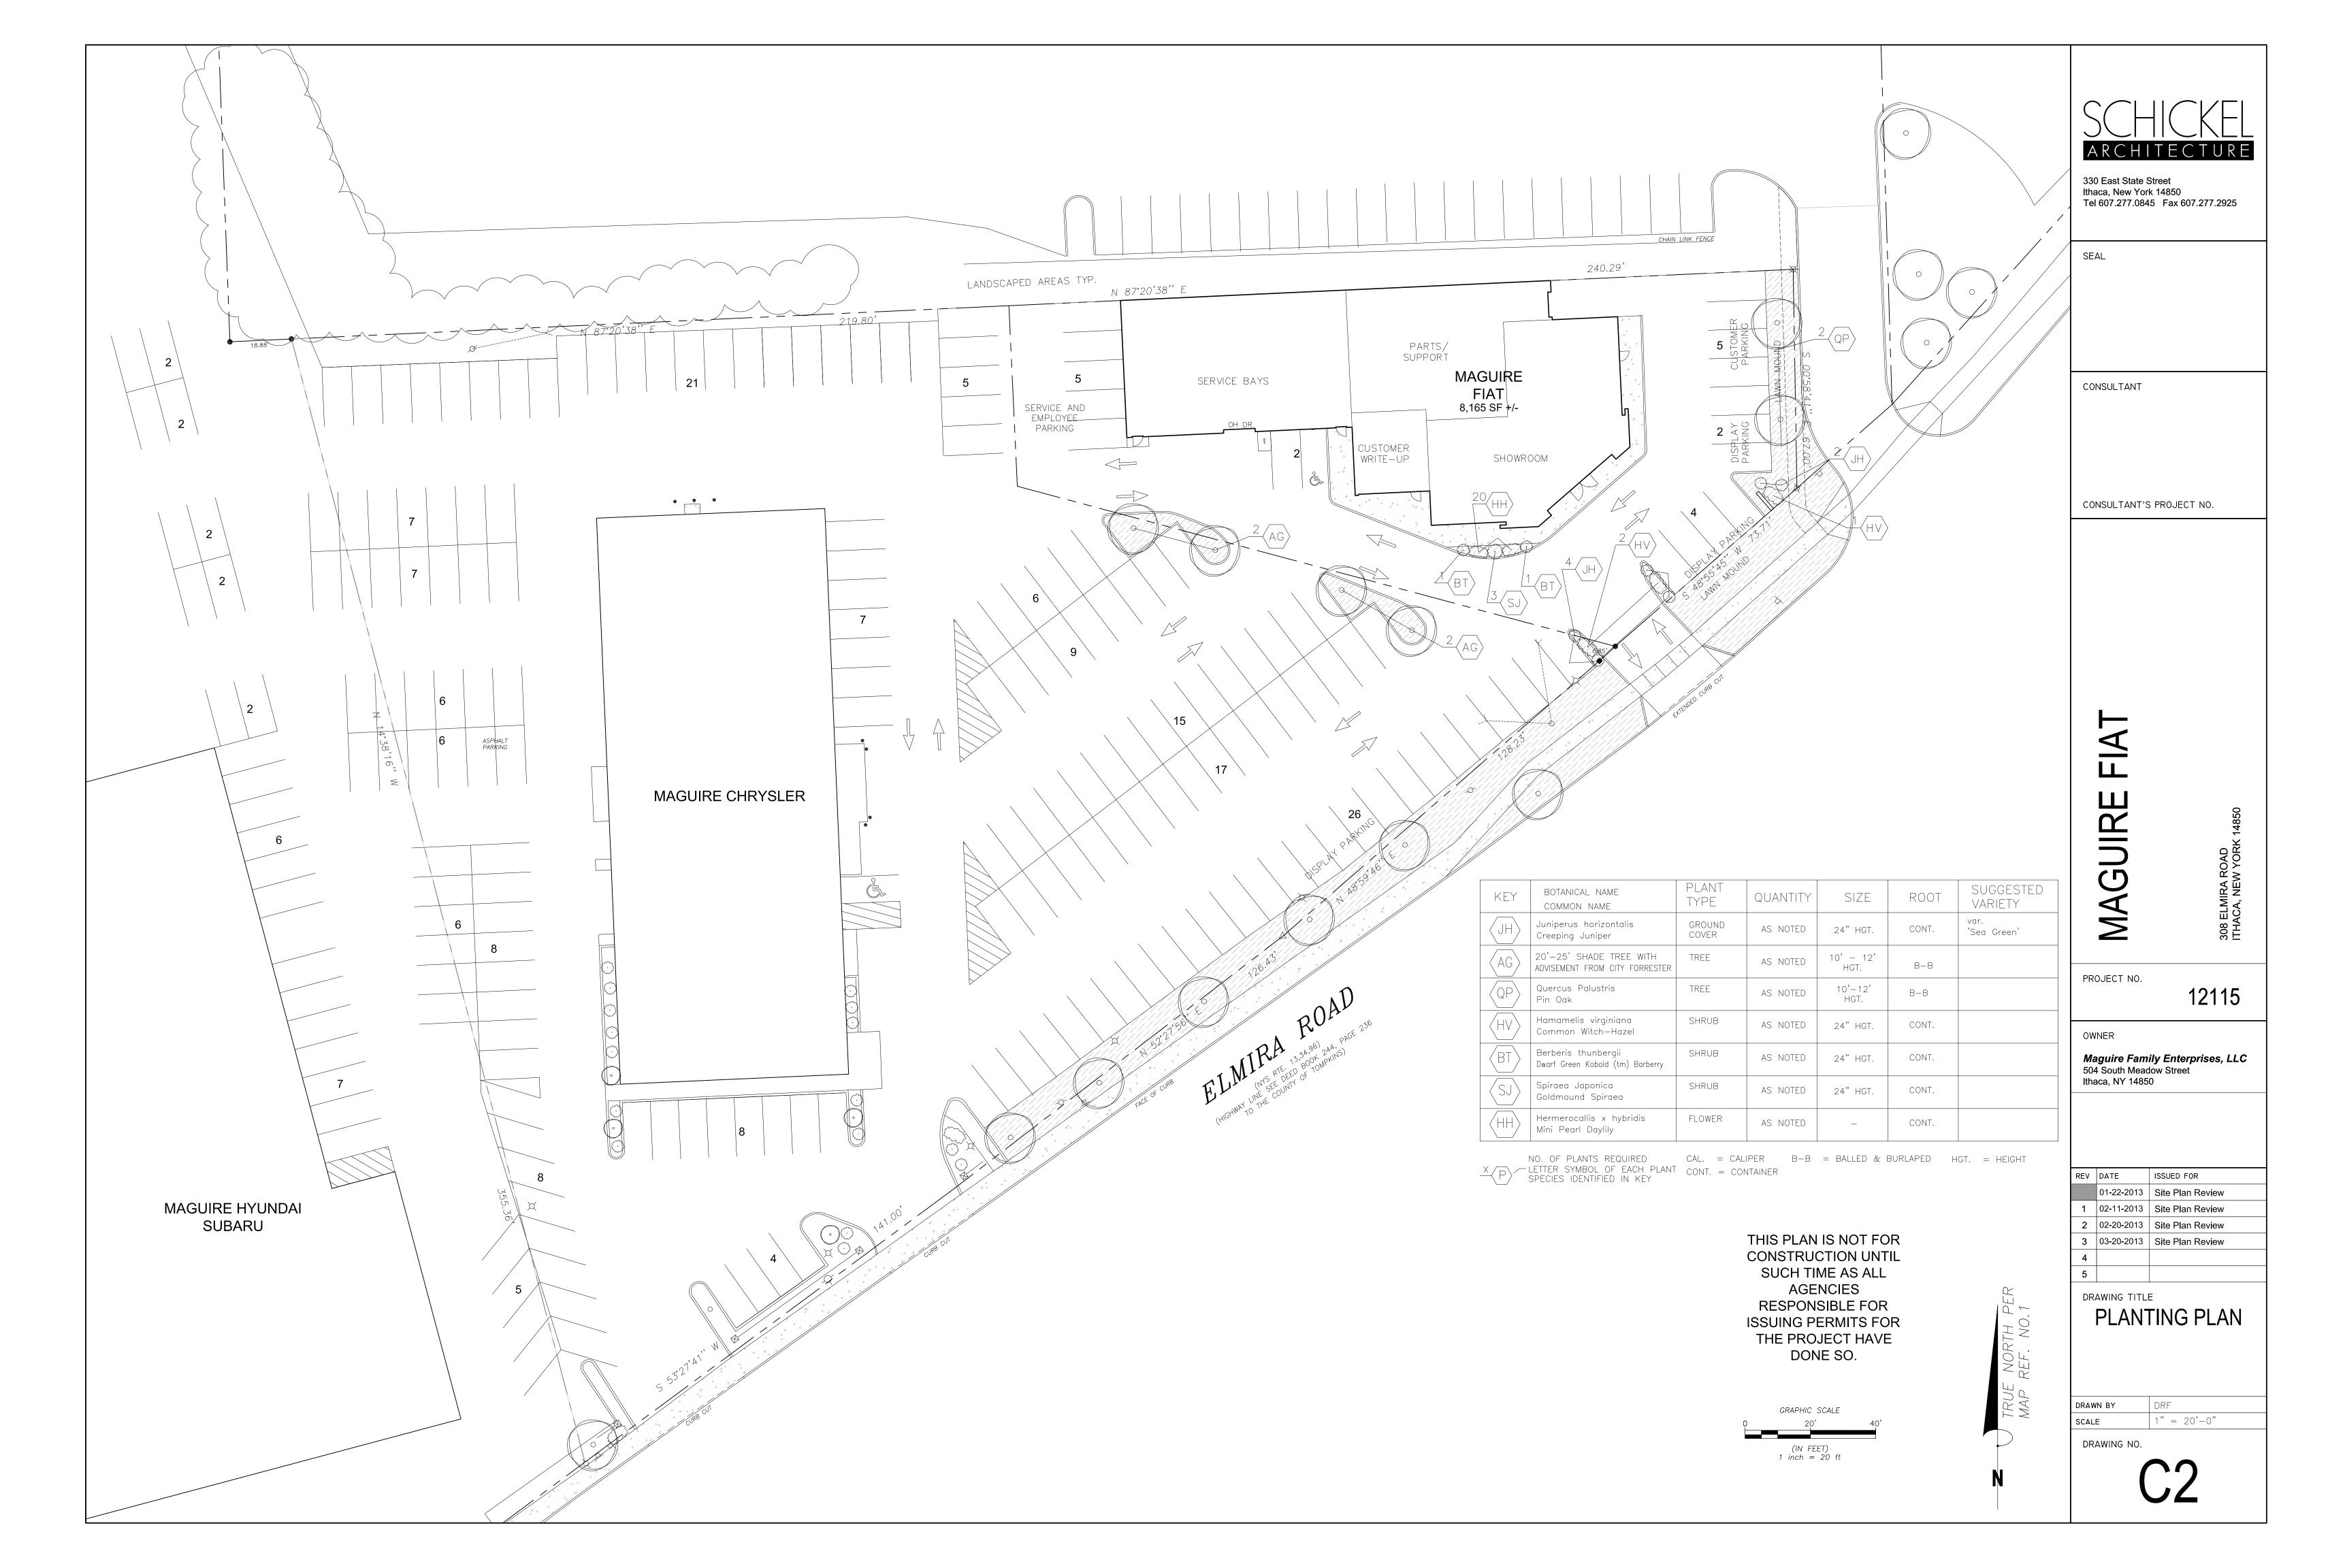
ELEVATIONS


DRAWN BY 1/8" = 1'-0"


DRAWING NO.



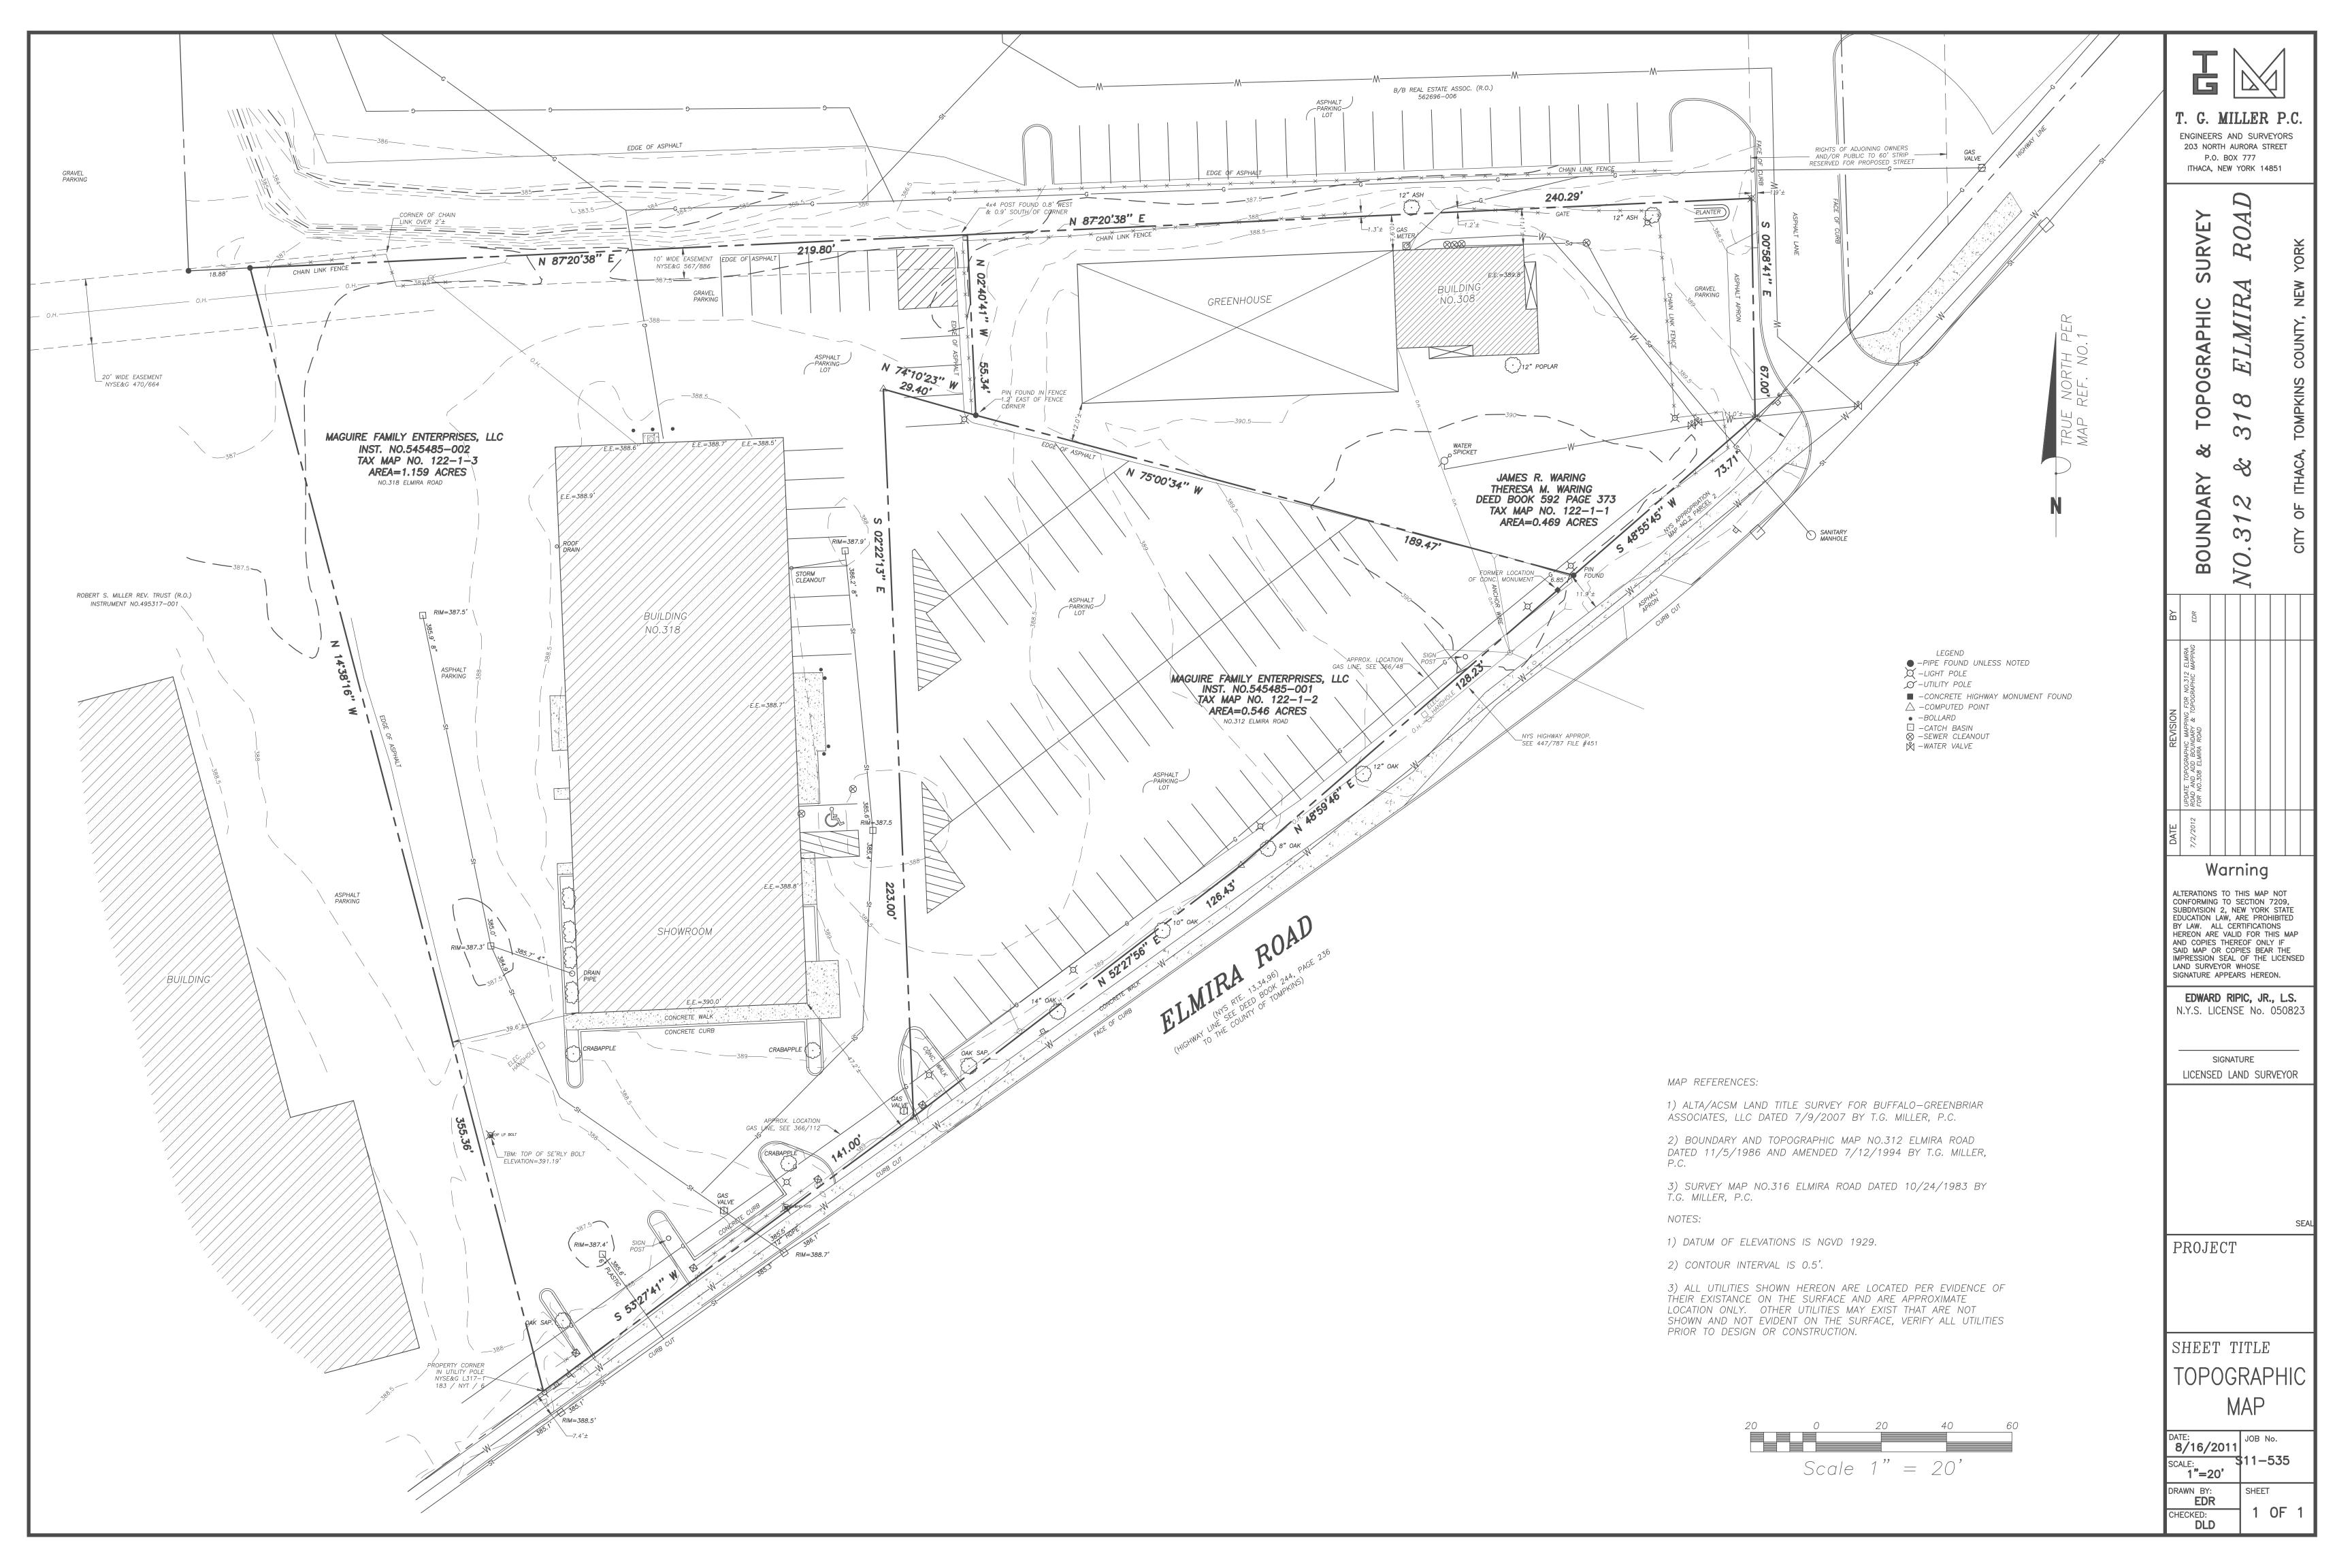

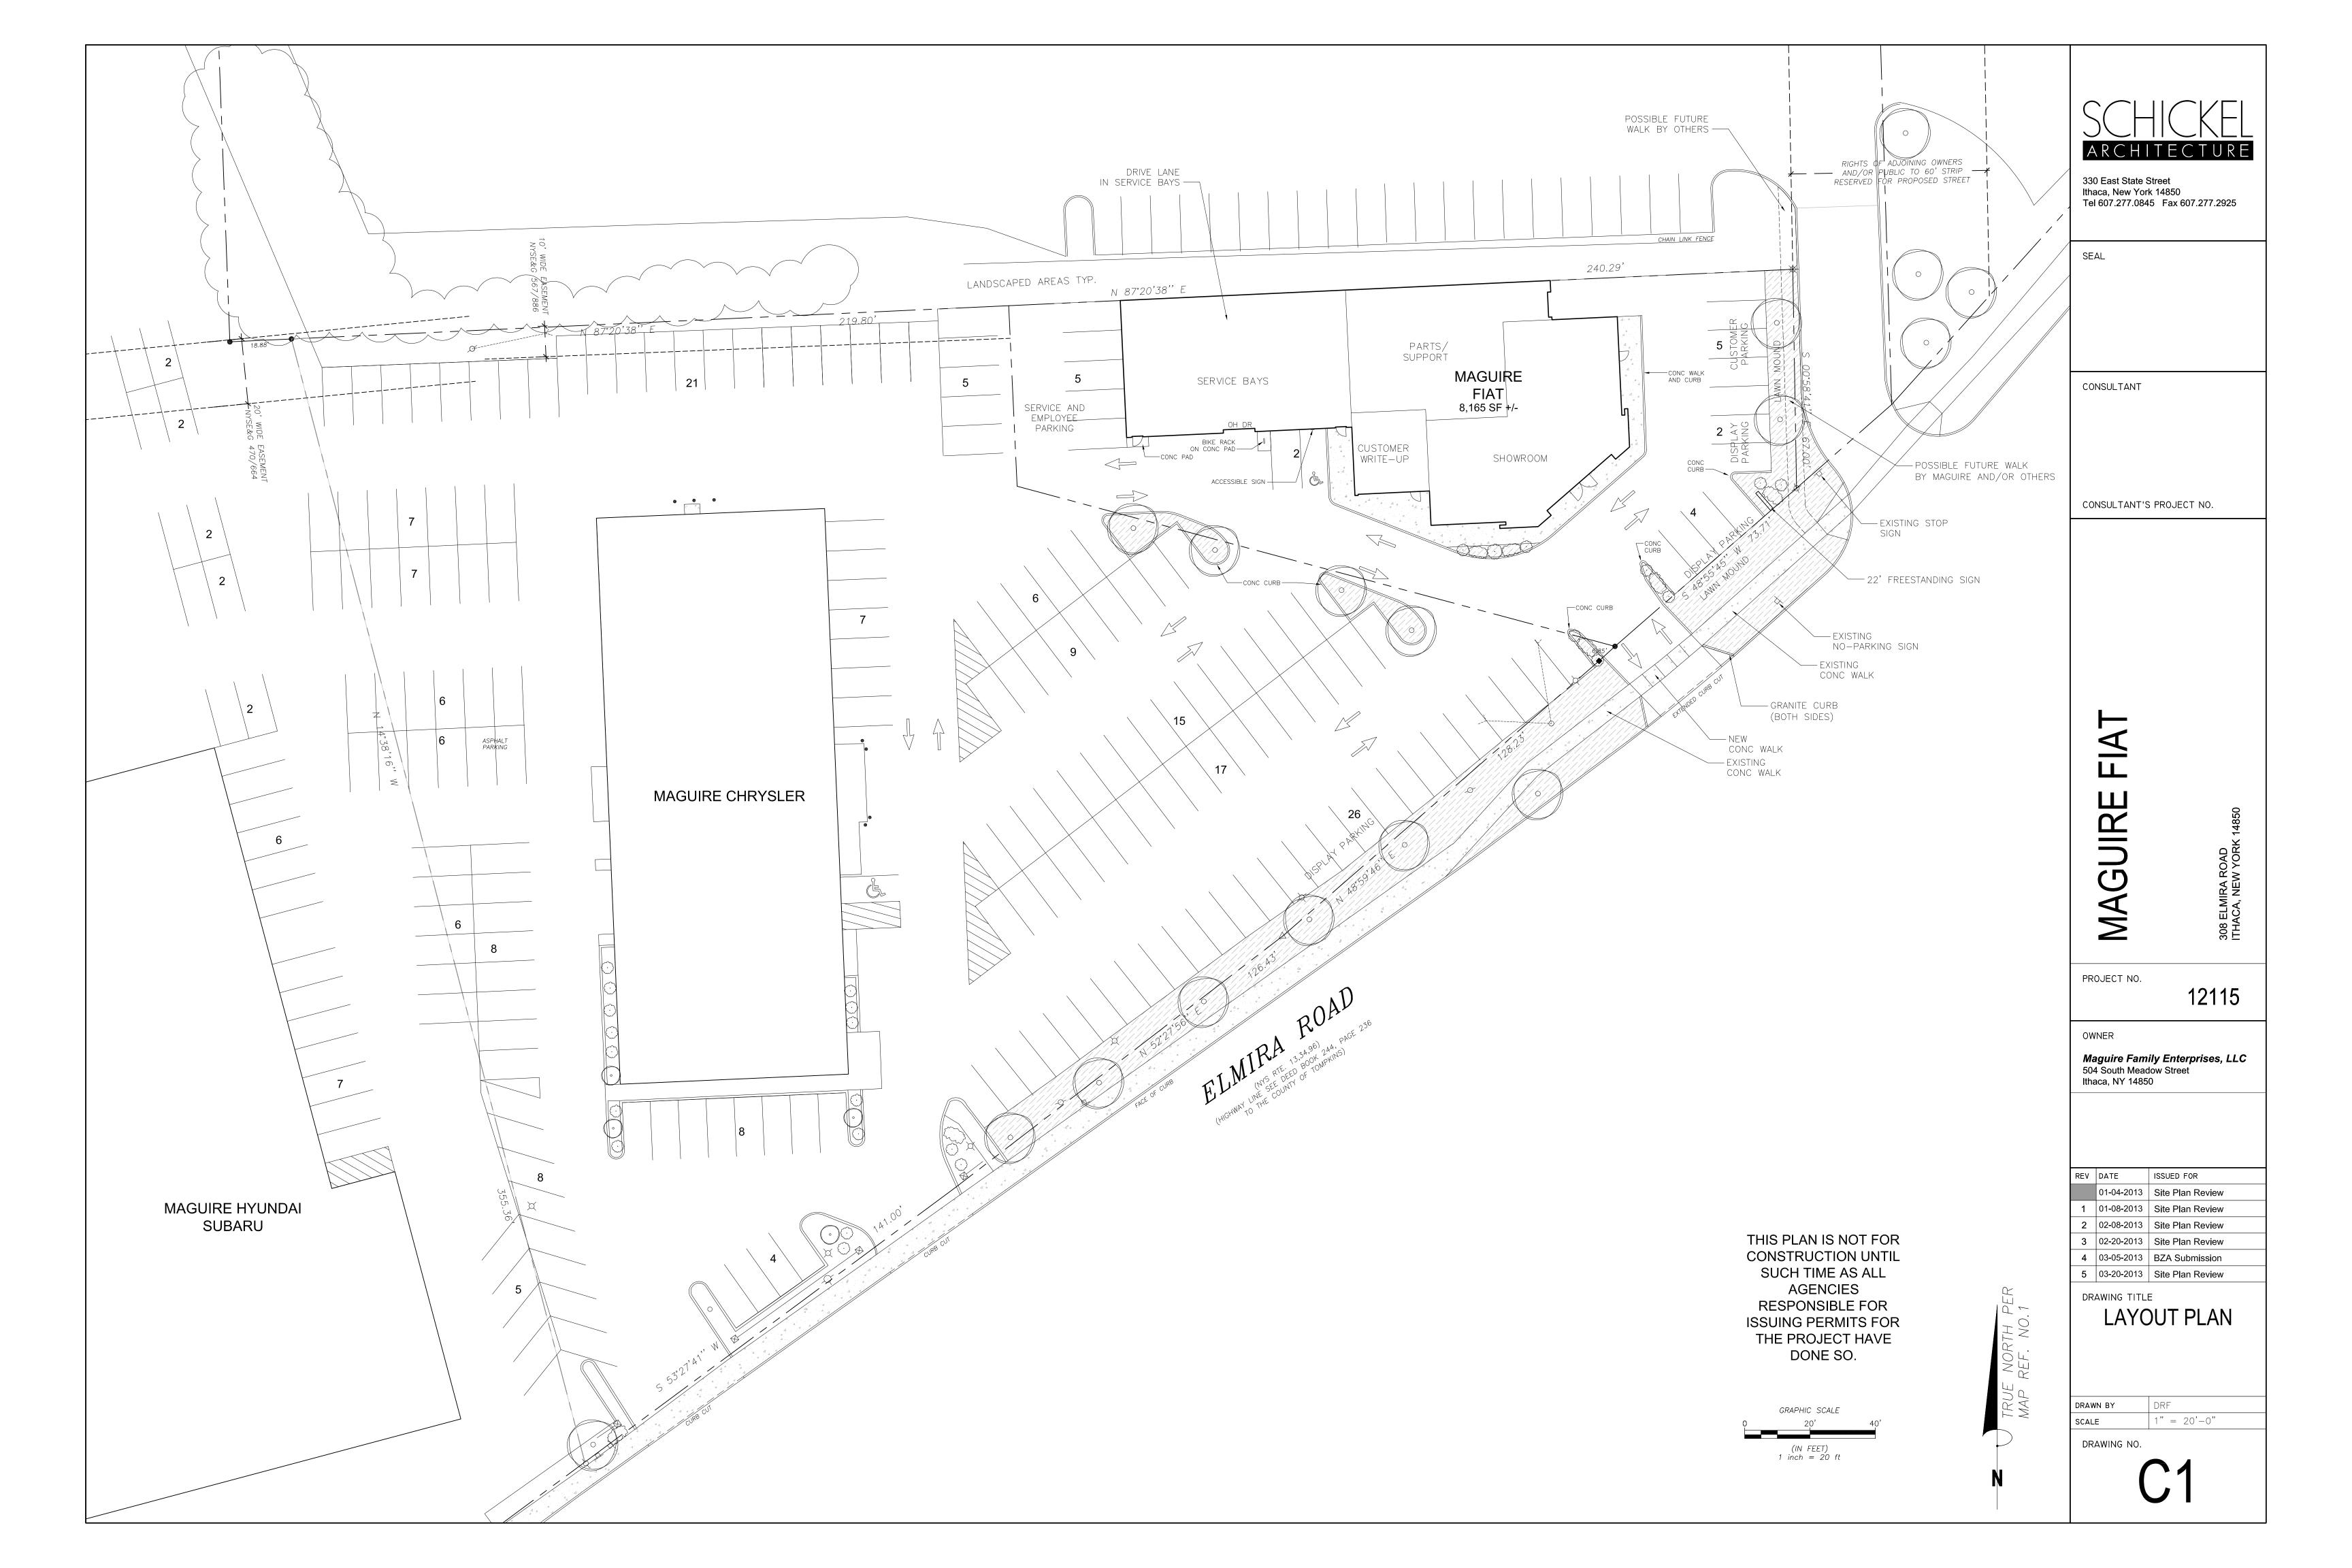

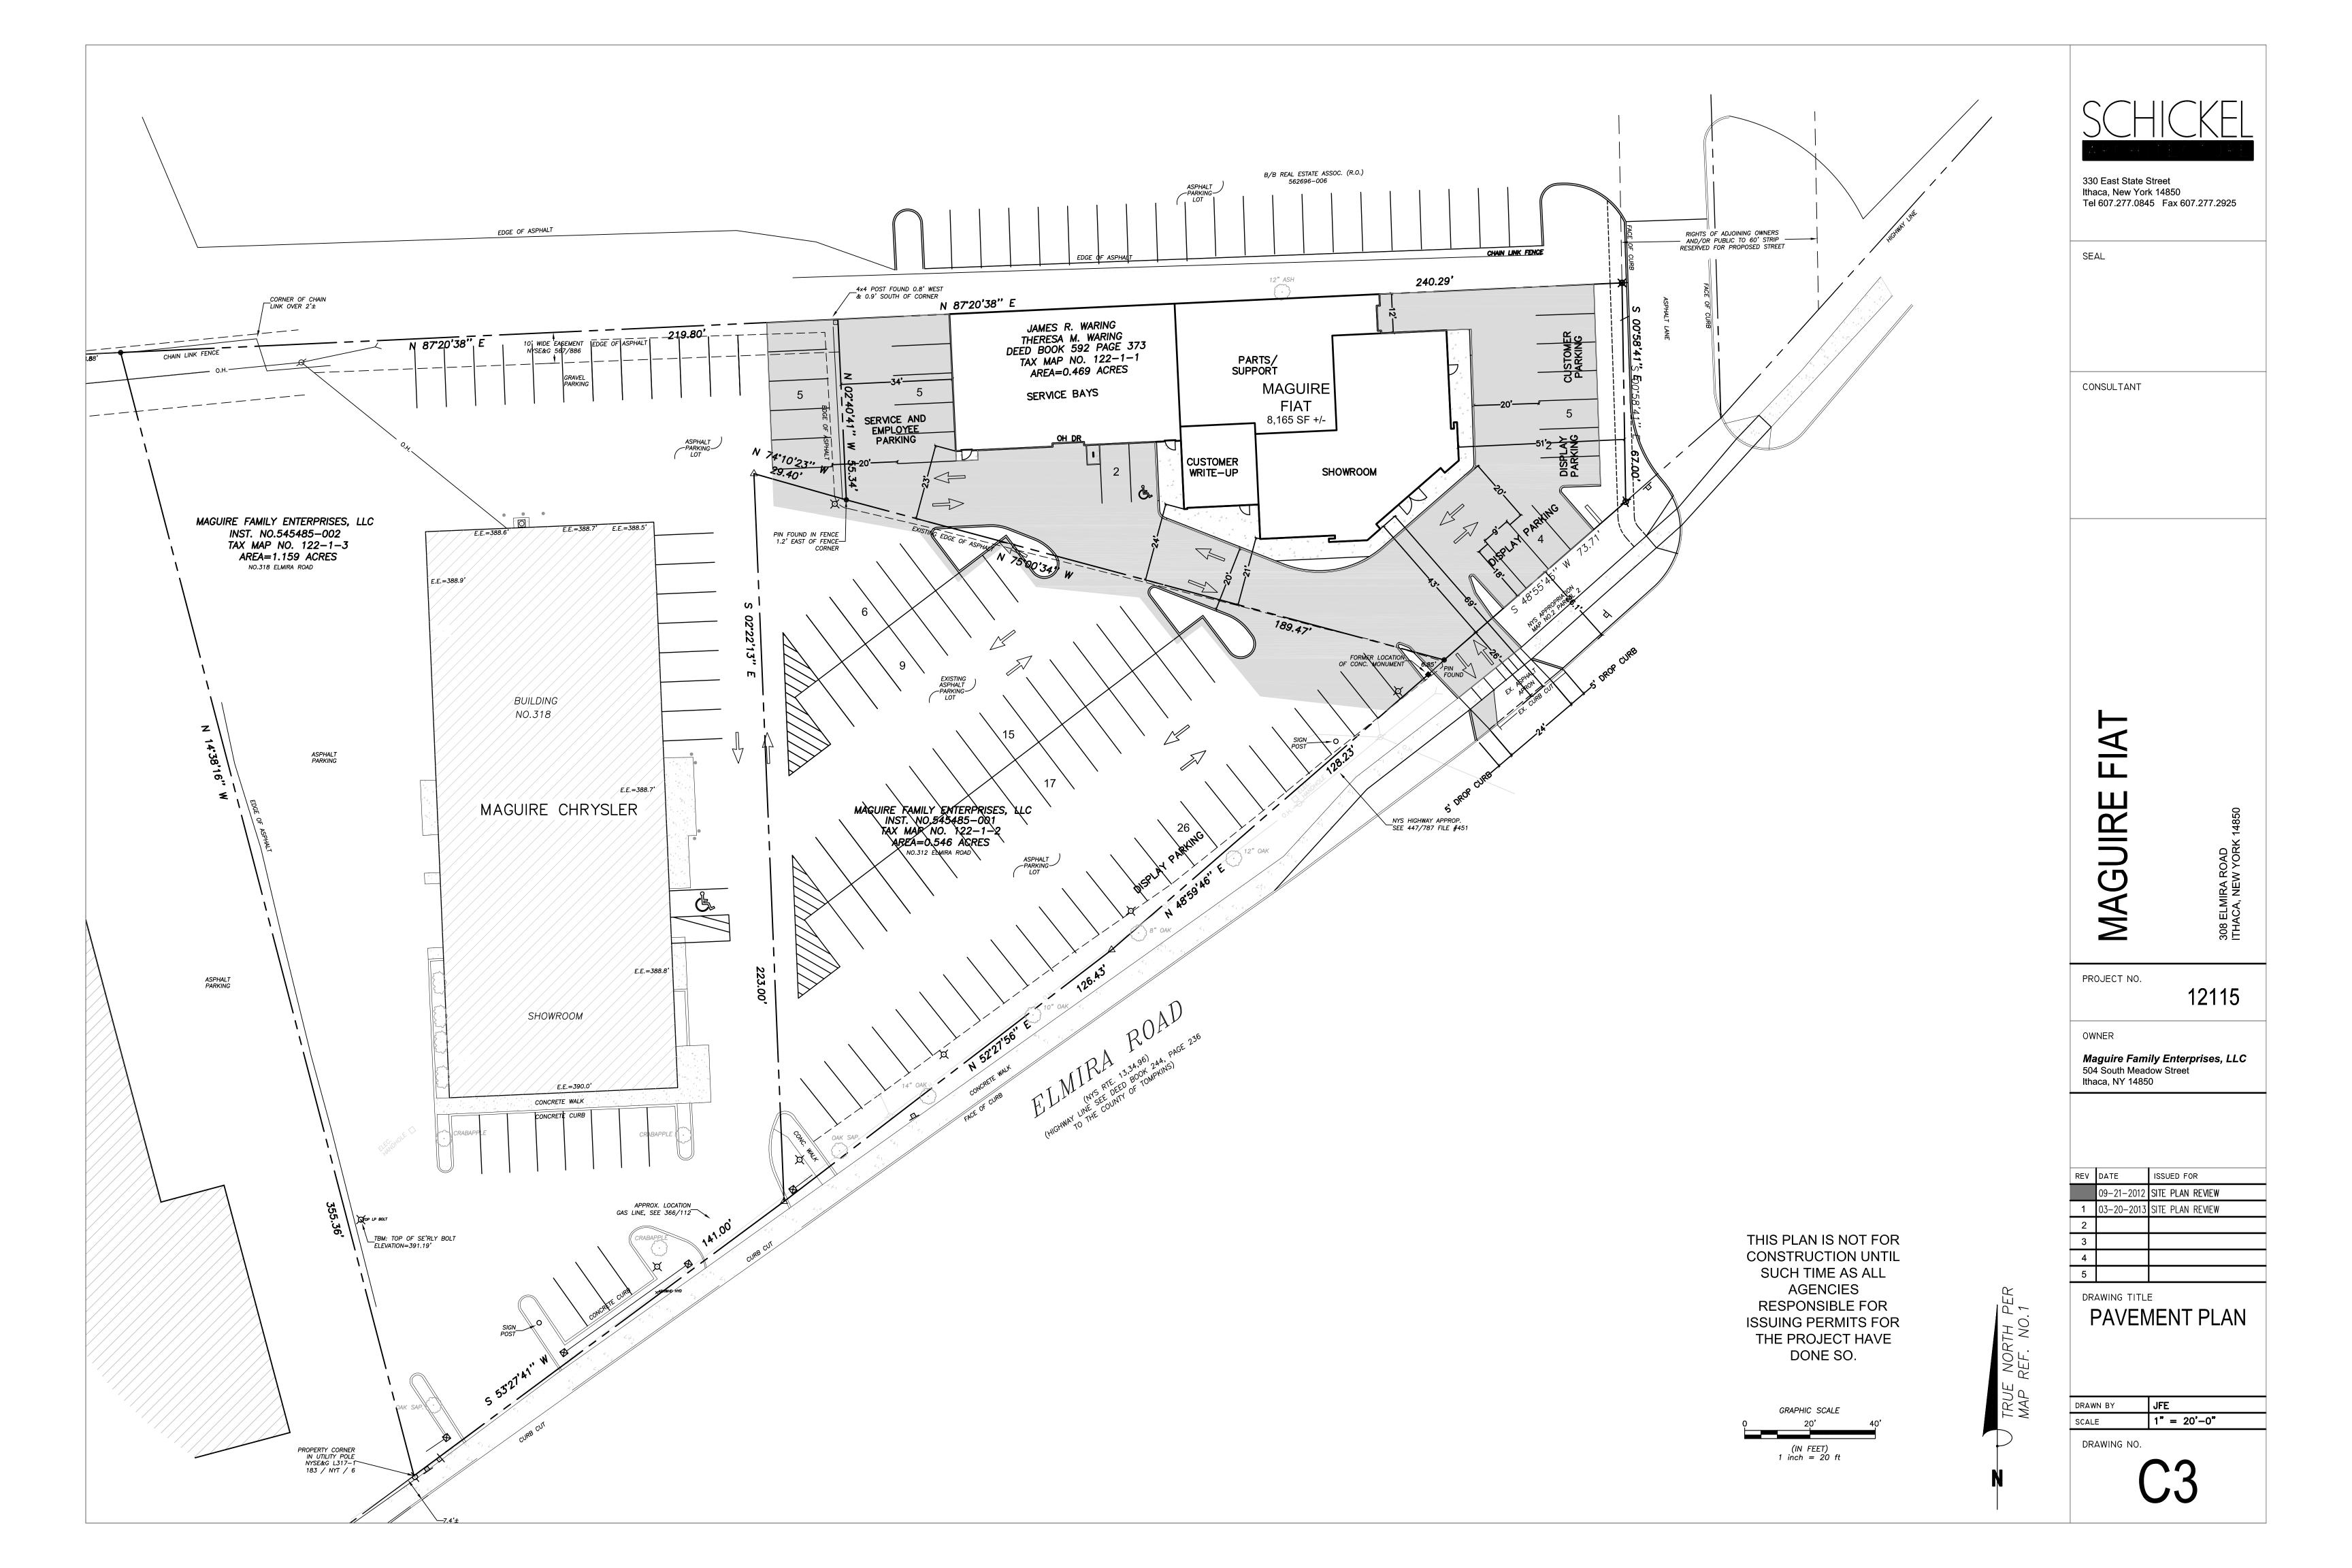

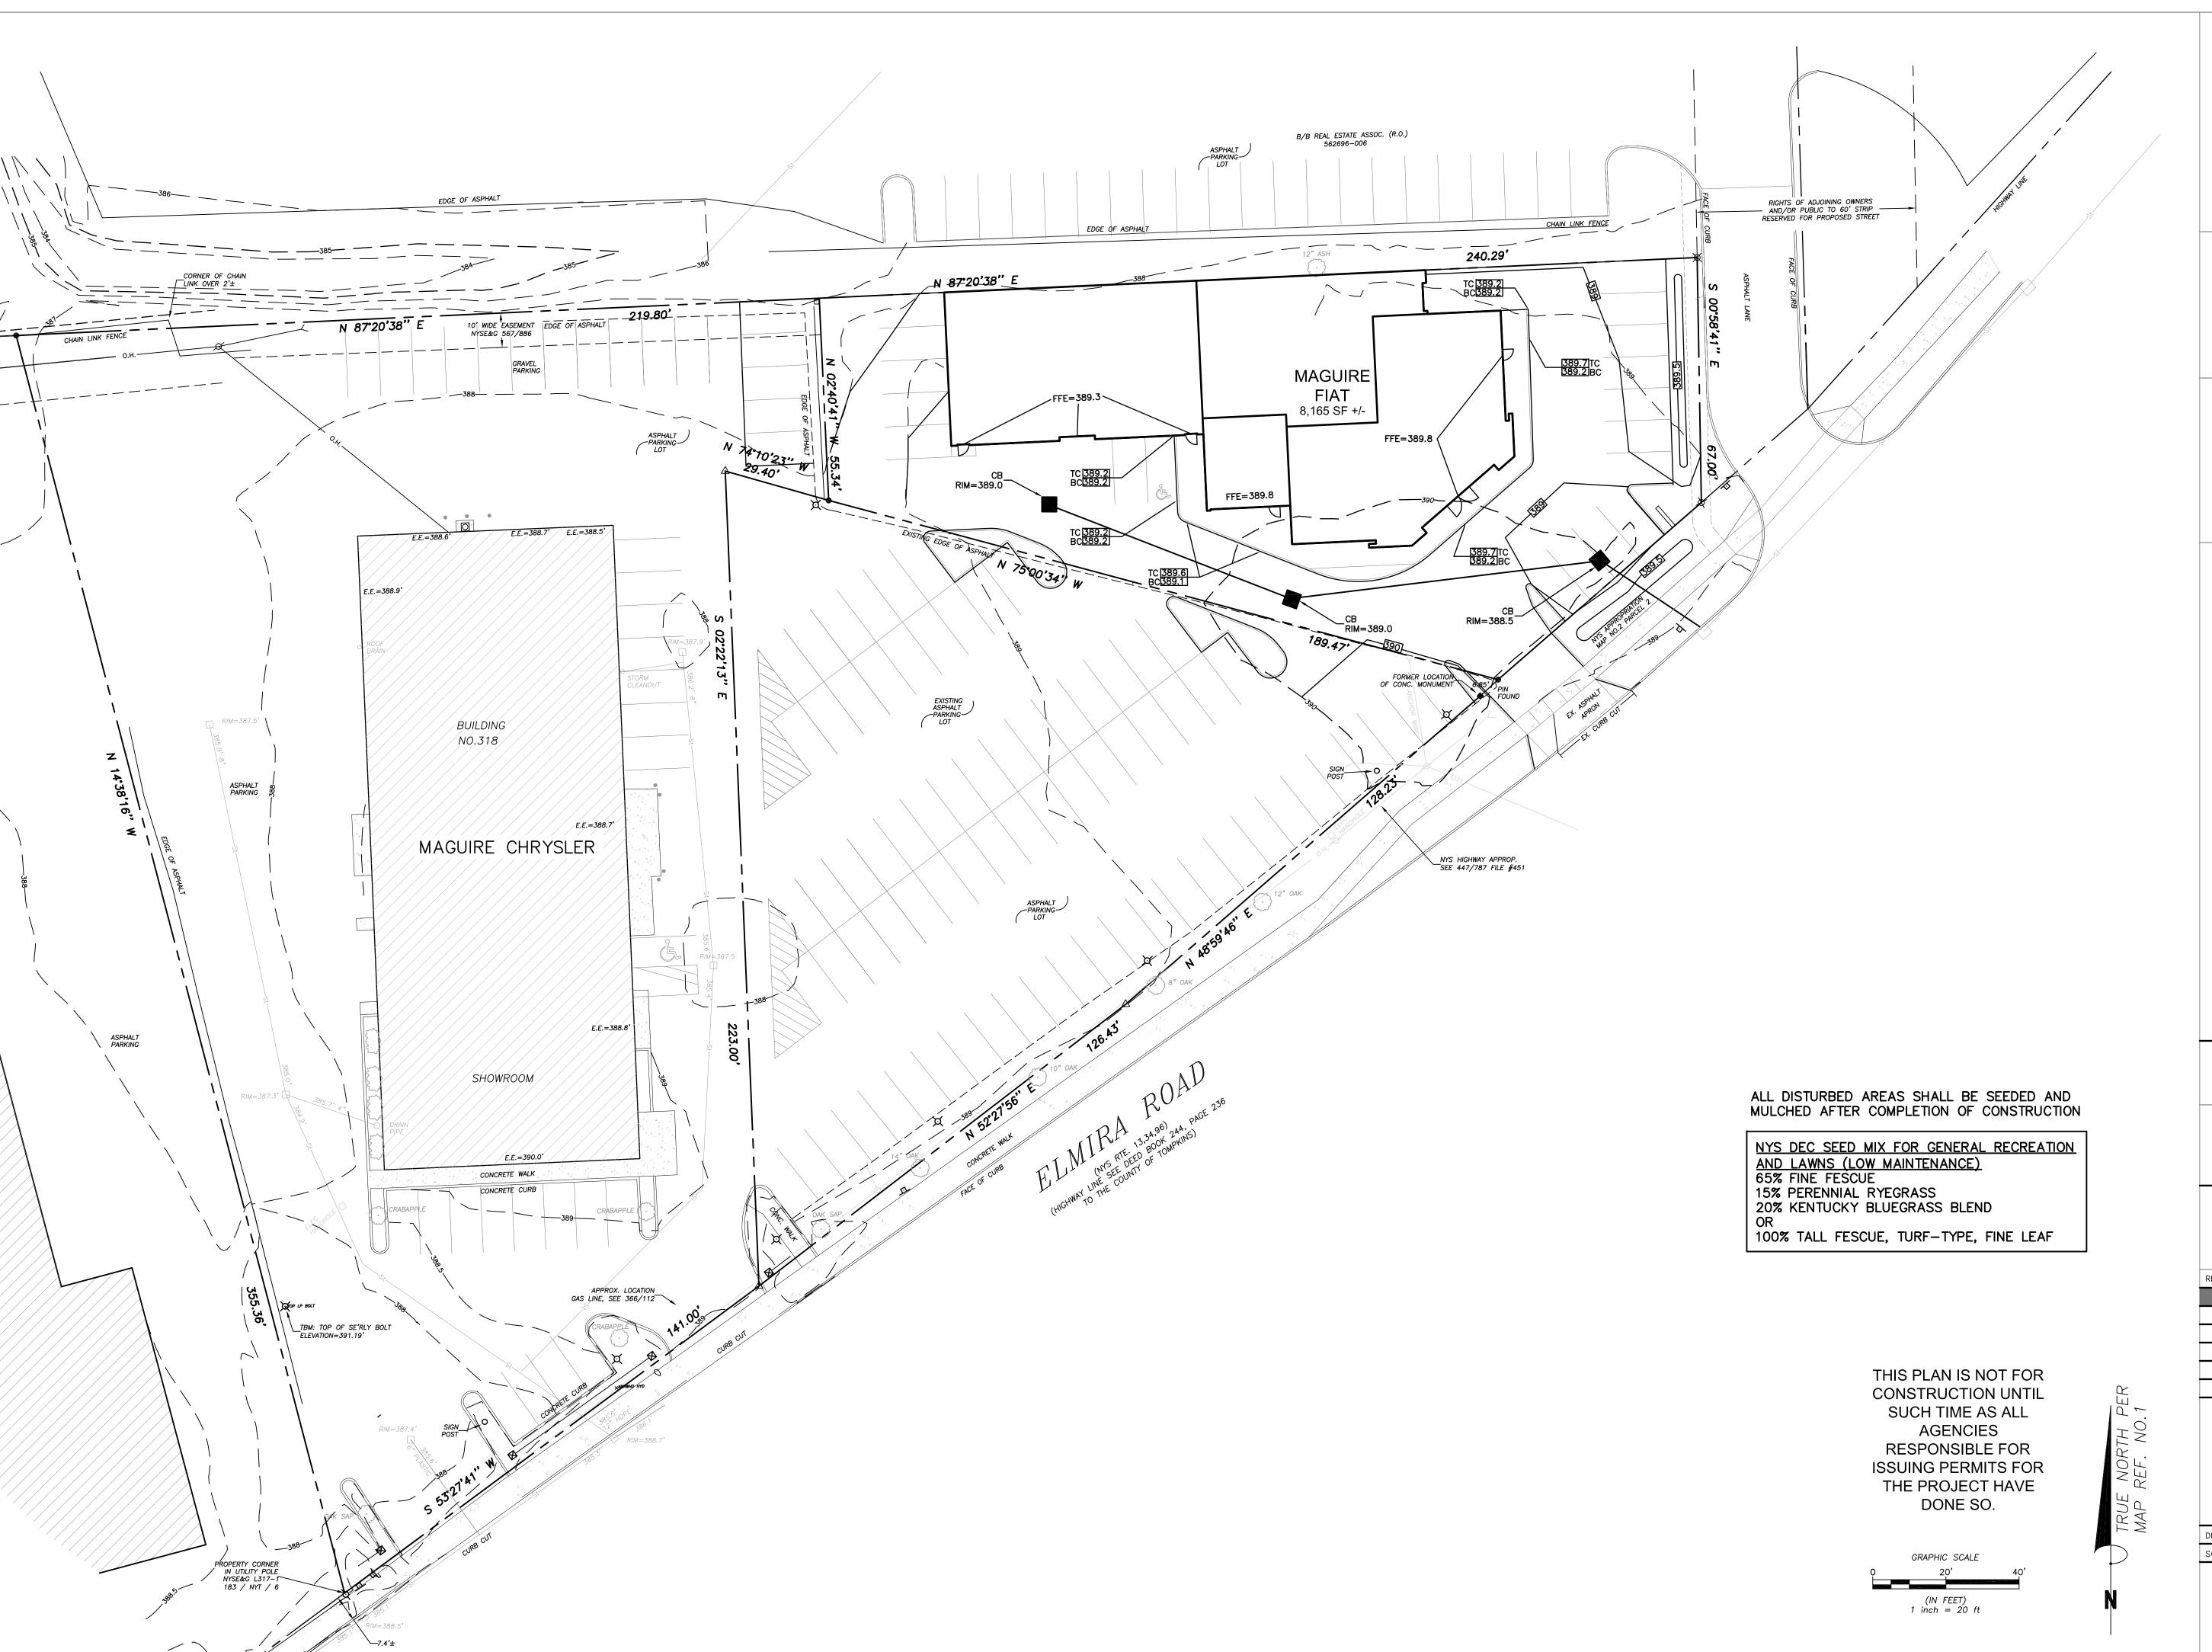

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SEAL

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CONSULTANT'S PROJECT NO. 12-1166

GUIRE FIAT

PROJECT NO.

12115

OWNER

Maguire Family Enterprises, LLC 504 South Meadow Street Ithaca, NY 14850

REV	DATE	ISSUED FOR
	09-21-2012	SITE PLAN REVIEW
1	03-20-2013	SITE PLAN REVIEW
2		
3		
4		


DRAWING TITLE

GRADING PLAN


RAWN BY	JFE
CALE	1" - 20'-0"

DRAWING NO.


C4

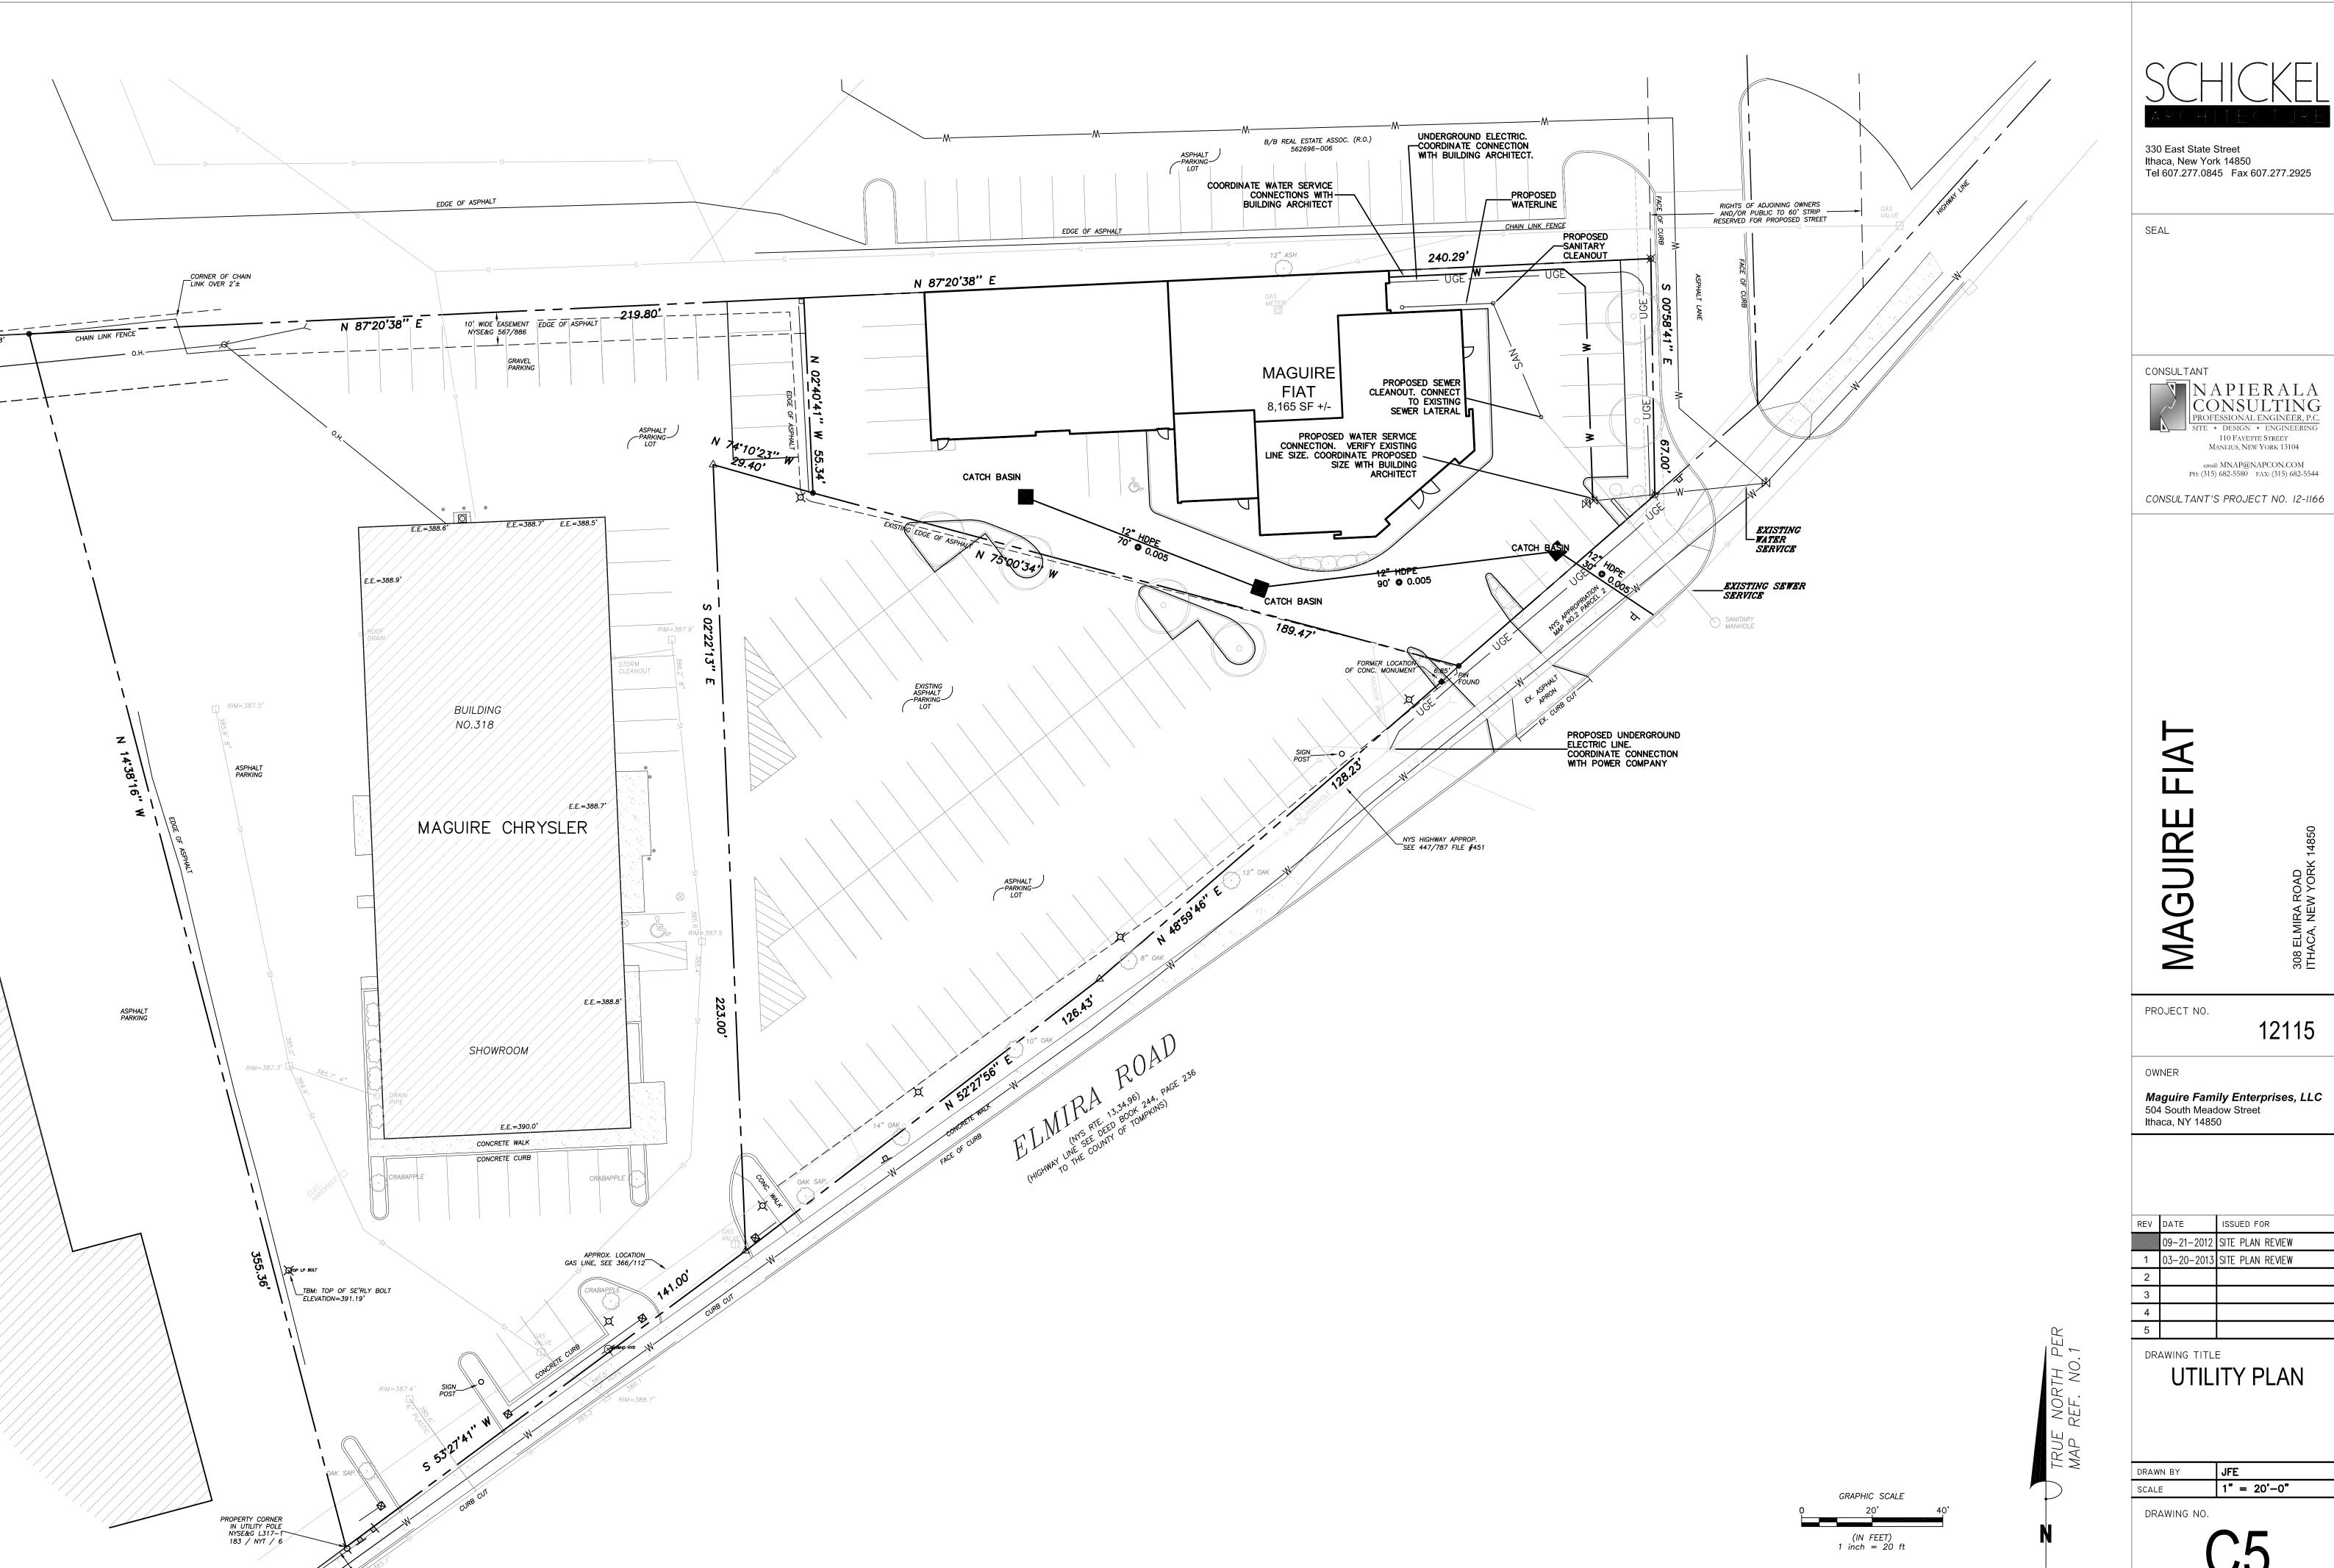

REV	DATE	ISSUED FOR
	09-21-2012	SITE PLAN REVIEW
1	03-20-2013	SITE PLAN REVIEW
2		
3		
4		
_		

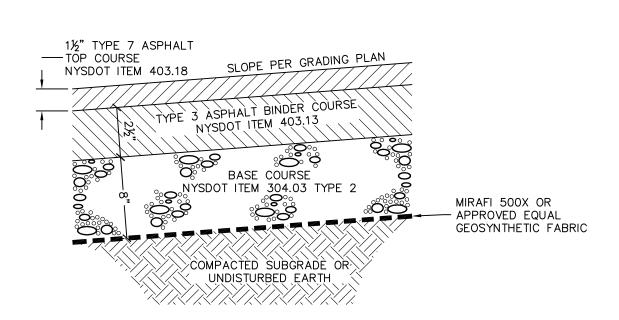



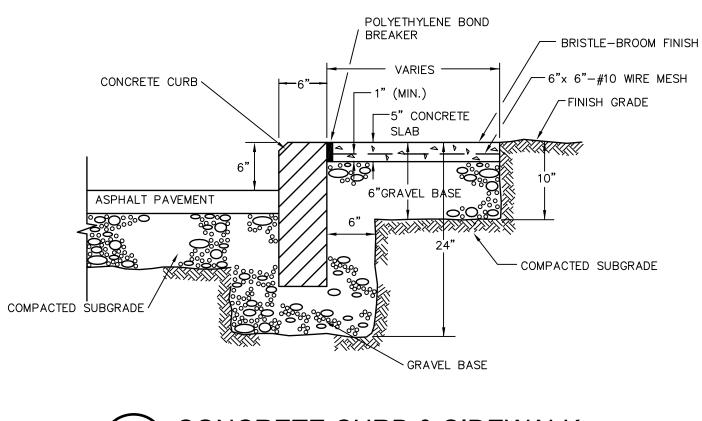

CONCRETE CURB & SIDEWALK SCALE: NTS **CROSS REFERENCE:**

FINISHED GRADE

OR PAVEMENT

EXTENSION - SAME

SIZE AS SEWER

PVC CLEANOUT PLUG

SANITARY SEWER -

SIZE AND MATERIAL

SEE UTILITY PLAN FOR

—11"*—*--**∤**

SANITARY SEWER CLEANOUT

SERVICE STATION CLEANOUT


FRAME AND COVER, SYRACUSE CASTINGS

PATTERN #4155

WYE - LONG SWEEP -

CROSS REFERENCE:

FLOW

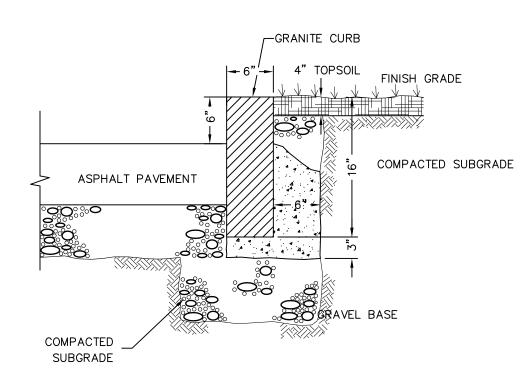

THIN BRANCHES AND FOLIAGE (NOT ALL

PREPARED SOIL MIX (PER CUBIC YARD):

% SCREENED LOAM AND % PEAT MOSS OR LEAF COMPOST. AMEND WITH

'PLANTONE' ORGANIC FERTILIZER, OR

EQUAL, AT THE RATE RECOMMENDED

ROLL BACK 沒 OF BURLAP

NON-BIODEGRADABLE MATERIALS

BEFORE BACKFILLING

- UNDISTURBED SUBGRADE

REMOVE WIRE AND

BY MANUFACTURER.

END TIPS) BY 1/3 RETAINING NATURAL PLANT SHAPE. NEVER CUT EVERGREEN

GRANITE CURB DETAIL SCALE: NTS CROSS REFERENCE:

½ ROOTBALL WIDTH

SCALE: NTS

CROSS REFERENCE:

SET PLANTS PLUMB AND_


3" SHREDDED BARK MULCH,

AT NATURAL GRADE

AS SPECIFIED

C6

3" EARTH SAUCER -

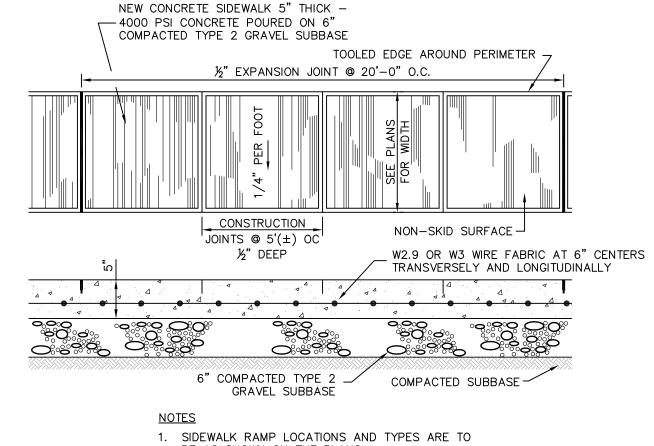


BE AS SHOWN ON THE PLANS.

2. SURFACE TEXTURE OF RAMP SHALL BE OBTAINED BY A COURSE BROOMING,


TRANSVERSE TO THE SLOPE OF THE RAMP. 3. NORMAL PAVEMENT EDGE PROFILE IS TO BE

MAINTAINED THROUGH THE AREA OF THE RAMP. 4. TRANSITION CURB FOR RAMPS SHALL BE 6-0" 5. MAXIMUM DESIRABLE RAMP SLOPE 1:12.


SIDEWALK DETAIL

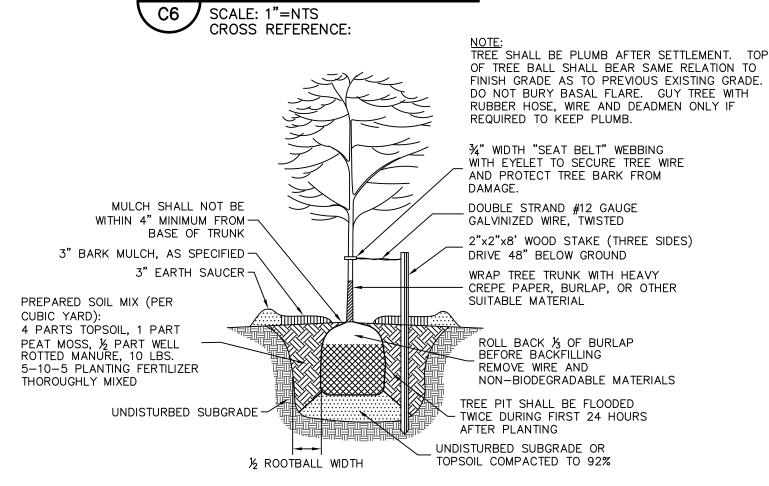



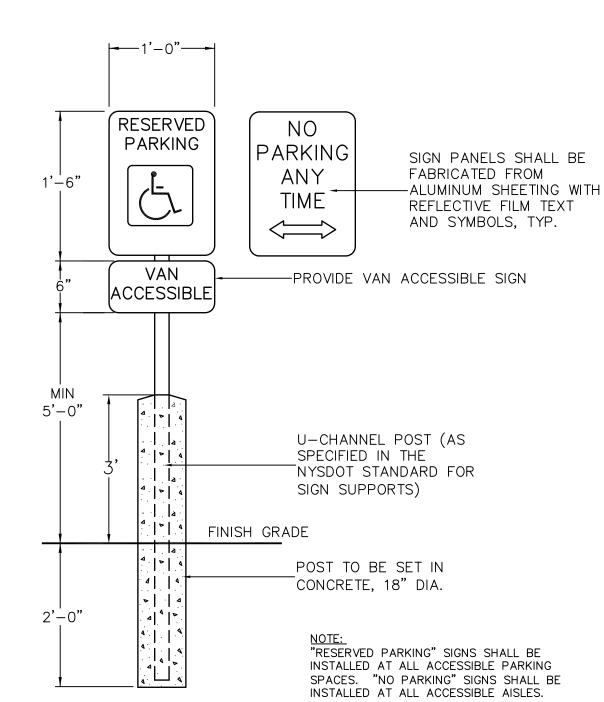



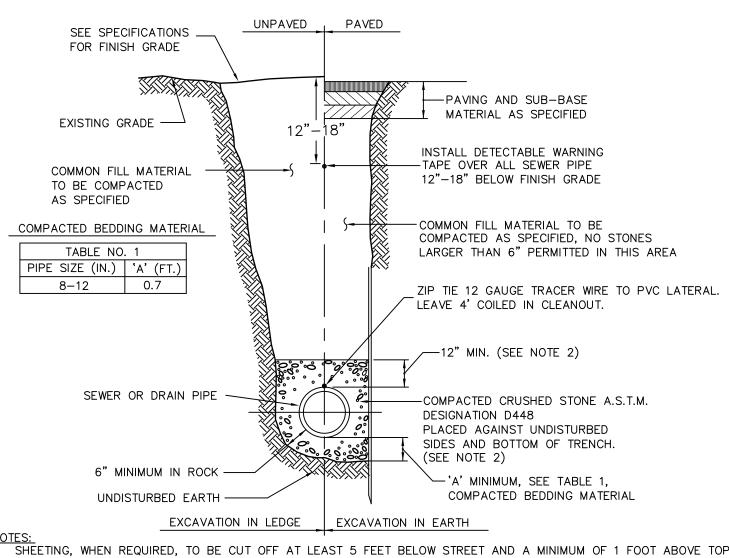


NOTES:

1. SHEETING, WHEN REQUIRED, TO BE CUT OFF AT LEAST 5 FEET BELOW STREET AND A MINIMUM OF 1 FOOT ABOVE TOP


SHEETING OF THE PIPE SHALL BE LEFT IN PLACE. STEFL SHEETING OF PIPE. WOOD SHEETING DRIVEN BELOW MID-DIAMETER OF THE PIPE SHALL BE LEFT IN PLACE. STEEL SHEETING DRIVEN BELOW MID-DIAMETER MAY BE WITHDRAWN IF APPROVED IN WRITING BY THE ENGINEER. FOR PVC PIPE ALL SHEETING DRIVEN BELOW MID-DIAMETER SHALL BE LEFT IN PLACE.


- 2. WHEN APPROVED BY THE ENGINEER FOR PIPES OTHER THAN PVC SELECTED GRAVEL FILL MATERIAL MAY BE USED FROM MID-DIAMETER OF PIPE TO 12" ABOVE TOP OF PIPE. NO STONES LARGER THAN 2 INCHES IN ANY DIMENSION WILL BE PERMITTED IN THIS AREA
- 3. TRENCHES LOCATED ON THE ROAD SHOULDER SHALL BE TREATED THE SAME AS EXCEPT FOR PAVING. 4. PROVIDE AT LEAST ONE IMPERVIOUS DAM IN GRAVEL BEDDING BETWEEN EACH MANHOLE WHERE DIRECTED, OR EVERY 300 FEET, WHICHEVER IS LESS. SEE DETAIL.
- 5. BEDDING MATERIAL FOR PVC PIPE SHALL MEET THE REQUIREMENTS OF ASTM D2321 CLASS I OR CLASS II EMBEDMENT



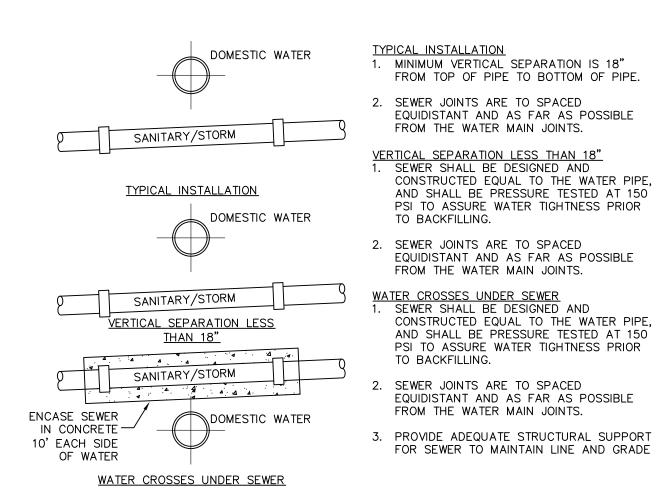




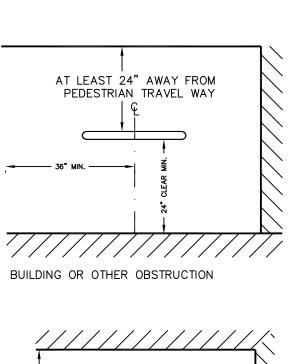

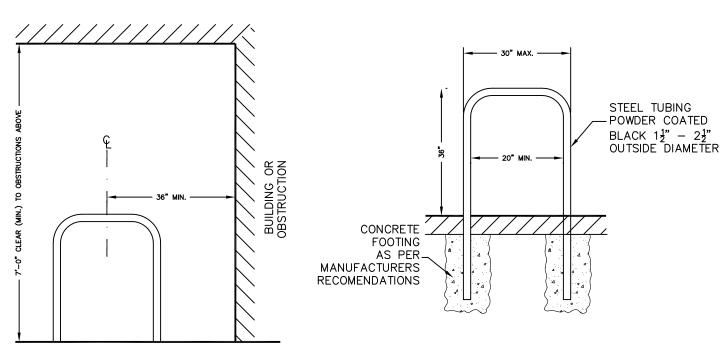

BICYCLE PARKING 10 TYPICAL DETAIL SCALE: NTS CROSS REFERENCE:

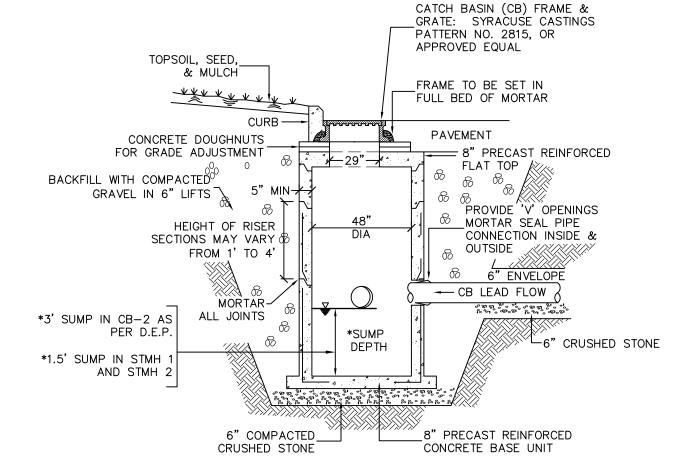

SHRUB PLANTING DETAIL

DRAINAGE STRUCTURE GENERAL NOTES 1. REINFORCING FOR ALL SECTIONS SHALL BE AS FOLLOWS: #3 BARS SPACED AT 4" IN BOTH DIRECTIONS. BOTTOM: #3 BARS SPACED AT 4" IN BOTH DIRECTIONS. #3 BARS SPACED AT 8" IN BOTH HORIZONTAL AND VERTICAL SIDES: 2. ALL REINFORCEMENT SHALL BE PLACED SO IT WILL HAVE A MINIMUM COVER OF 2" AND BE LOCATED APPROXIMATELY WITHIN THE CENTER OF THE 3. TOP SLAB AND/OR FRAME ADJUSTMENT:

FOR ALL DRAINAGE STRUCTURES A MAXIMUM OF 6 INCHES OF BRICK AND MORTAR OR A MAXIMUM OF 2 INCHES OF MORTAR ALONE SHALL BE USED FOR TOP SLAB AND/OR FRAME & GRATE ADJUSTMENT. FOR ADJUSTMENTS OVER 6 INCHES AND NOT TO EXCEED 12 INCHES, PRECAST CONCRETE ADJUSTMENT ELEMENT(S) MANUFACTURED IN ACCORDANCE WITH NYS-DOT STANDARD SPEC SUB-SECTION #706-04 SHALL BE USED; A MAXIMUM OF 2 INCHES OF MORTAR SHALL BE ALLOWED ON BOTH THE TOP AND BOTTOM OF THE PRECAST DEVICES. BRICK SHALL BE PRECAST PAVERS CONFORMING TO NYS-DOT STANDARD SPEC SUB-SECTION #704-13 AND MORTAR SHALL BE MORTAR FOR CONCRETE MASONRY CONFORMING TO NYS-DOT STANDARD SPEC SUB-SECTION

4. MANHOLE STEPS SHALL BE REQUIRED IN ALL DRAINAGE STRUCTURES DEEPER THAN 4 FEET. STEPS SHALL CONFORM TO NYS-DOT STANDARD SPEC

5. BASE OF PRECAST CATCH BASIN SHALL REST ON BASE MATERIAL COMPACTED IN PLACE WITH A VIBRATORY MECHANICAL TAMPER IN LIFTS NOT TO

EXCEED 6" AT A TIME. 6. TRENCH SIDES SHALL CONFORM TO NYS DEPT OF LABOR AND OSHA SAFETY REGULATIONS.

PRECAST CATCH BASIN SCALE: NTS

SUB-SECTION #725-02.

CROSS REFERENCE:



CONSULTANT NAPIERALA ONSULTING OFESSIONAL ENGINEER, P.C TE • DESIGN • ENGINEERING 110 FAYETTE STREET Manlius, New York 13104 email: MNAP@NAPCON.COM PH: (315) 682-5580 FAX: (315) 682-5544 CONSULTANT'S PROJECT NO. 12-1166

GUIR

PROJECT NO. 12115 Maguire Family Enterprises, LLC 504 South Meadow Street Ithaca, NY 14850 REV ISSUED FOR 09-21-2012 SITE PLAN REVIEW 1 | 03-20-2013 | SITE PLAN REVIEW

SITE DETAILS DRAWN BY JFE AS NOTED

SCALE DRAWING NO.

DRAWING TITLE





331<u>2</u>7113313 1 4X 3311<u>2</u>711<u>2</u>

CONSULTANT

SEAL

CONSULTANT'S PROJECT NO.

3UIRE FIAT

MAGUIRE

PROJECT NO.

12115

OWNER

Maguire Family Enterprises, LLC 504 South Meadow Street Ithaca, NY 14850

REV DATE ISSUED FOR

01-04-2013 BZA Submission

1
2
3

DRAWING TITLE


FLOOR PLAN


DRAWN BY DRF

SCALE 1/8" = 1'-0"

DRAWING NO.

A1

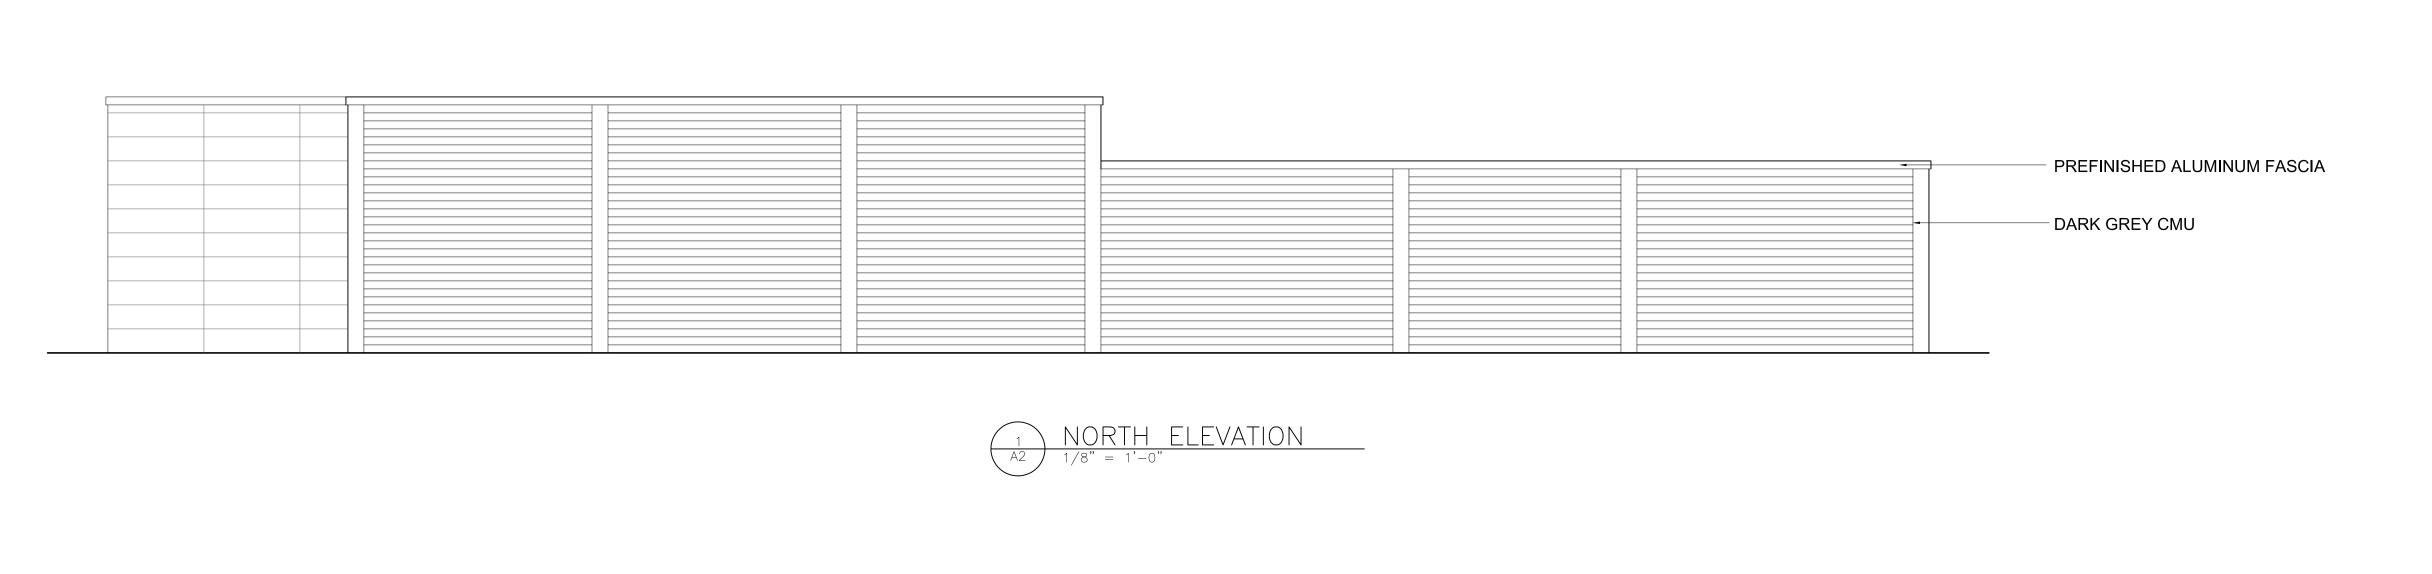

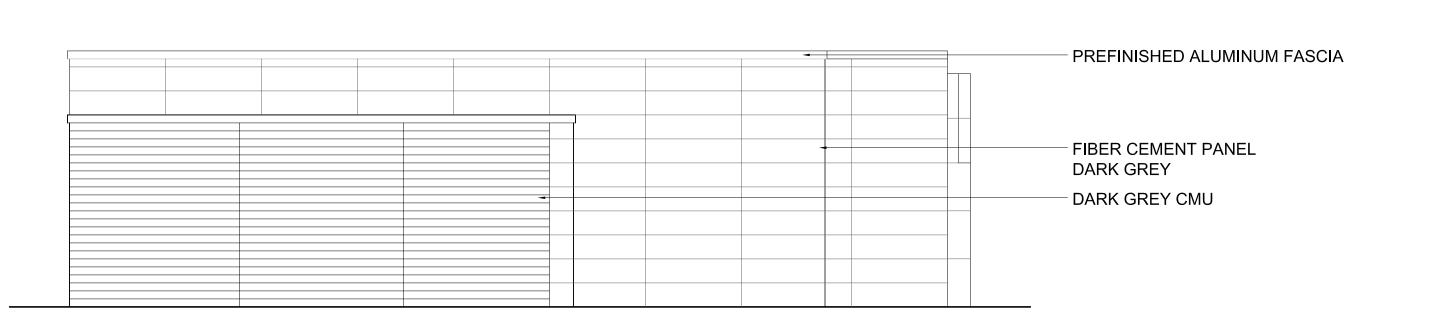


WEST ELEVATION

A2 1/8" = 1'-0"


EAST ELEVATION

A2 1/8" = 1'-0"

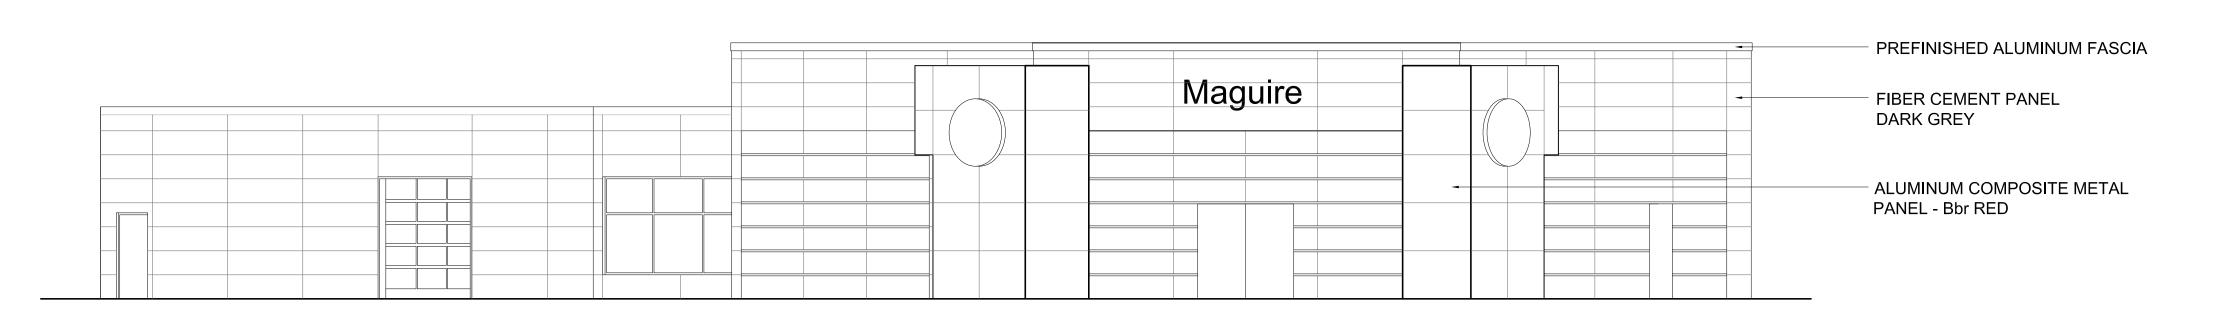

SOUTHEAST ELEVATION

A2 1/8" = 1'-0"

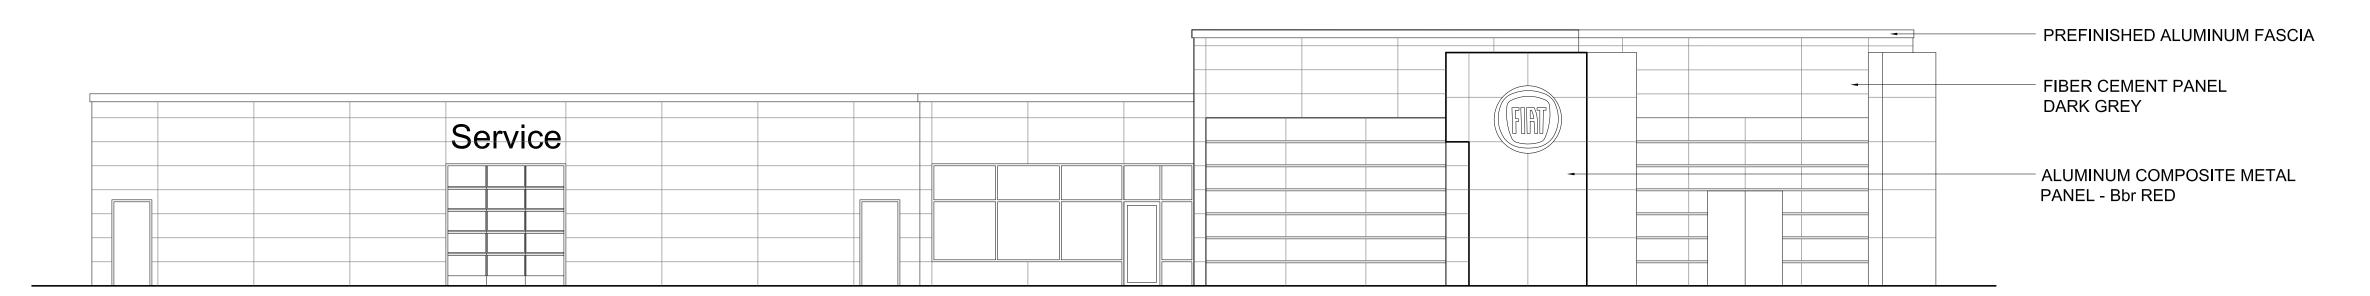





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 REV
 DATE
 ISSUED FOR

 01-04-2013
 BZA Submission

 1
 01-18-2013
 BZA Submission

 2
 02-08-2013
 BZA Submission

 3
 4

DRAWING TITLE

ELEVATIONS

DRAWN BY DRF

SCALE 1/8" = 1'-0"

DRAWING NO.

A2